


POWER PLAN

GENERAL NOTES:

1. ALL SIGNS TO HAVE SEPARATE DISCONNECTS PER NEC 600-6..
2. ALL RECEPTACLES MOUNTED AT 24" A.F.F UNLESS NOTED OTHERWISE.
3. SEE SHEET "A-2.1" FOR EQUIPMENT SCHEDULE.
4. ROUGH-INS AND FINAL CONNECTIONS FOR ALL OWNER FURNISHED EQUIPMENT BY E.C. UNLESS NOTED OTHERWISE
5. ALL EMPTY CONDUITS TO HAVE PULL WIRE
6. AT COOLER FREEZERS, PROVIDE COUNDUIT SEALS PER NEC. 300-7

| LIGHT FIXTURE SCHEDULE |       |      |   |            |       |       |
|------------------------|-------|------|---|------------|-------|-------|
| SYMBOL                 | CRCT. | QYT. | DESCRIPTION                                     | LENS       | WATTS | VOLTS |
| CS 1                   | 4,5,6 | 20   | RECESSED "LAY-IN" FLUORESCENT 2'X4' - 3 LAMPS   | ACRYLIC    | 128   | 120   |
| CS 2                   | 5     | 3    | RECESSED "LAY-IN" FLUORESCENT 1'X4' - 2 LAMPS   | ACRYLIC    | 64    | 120   |
| CS 3                   | 7     | 8    | COOLER LIGHTS WITH LENS, GASKET, AND CAST GUARD | FIBERGLASS | 54    | 120   |
| CS 4                   | 8     | 3    | RECESSED LENSED METAL HALIDE CAN LIGHT          | FRESNEL    | 100   | 120   |
| CS 5                   | 9     | 7    | WALL PACKS (WEATHER-PROOF)                      | ACRYLIC    | 175   | 120   |

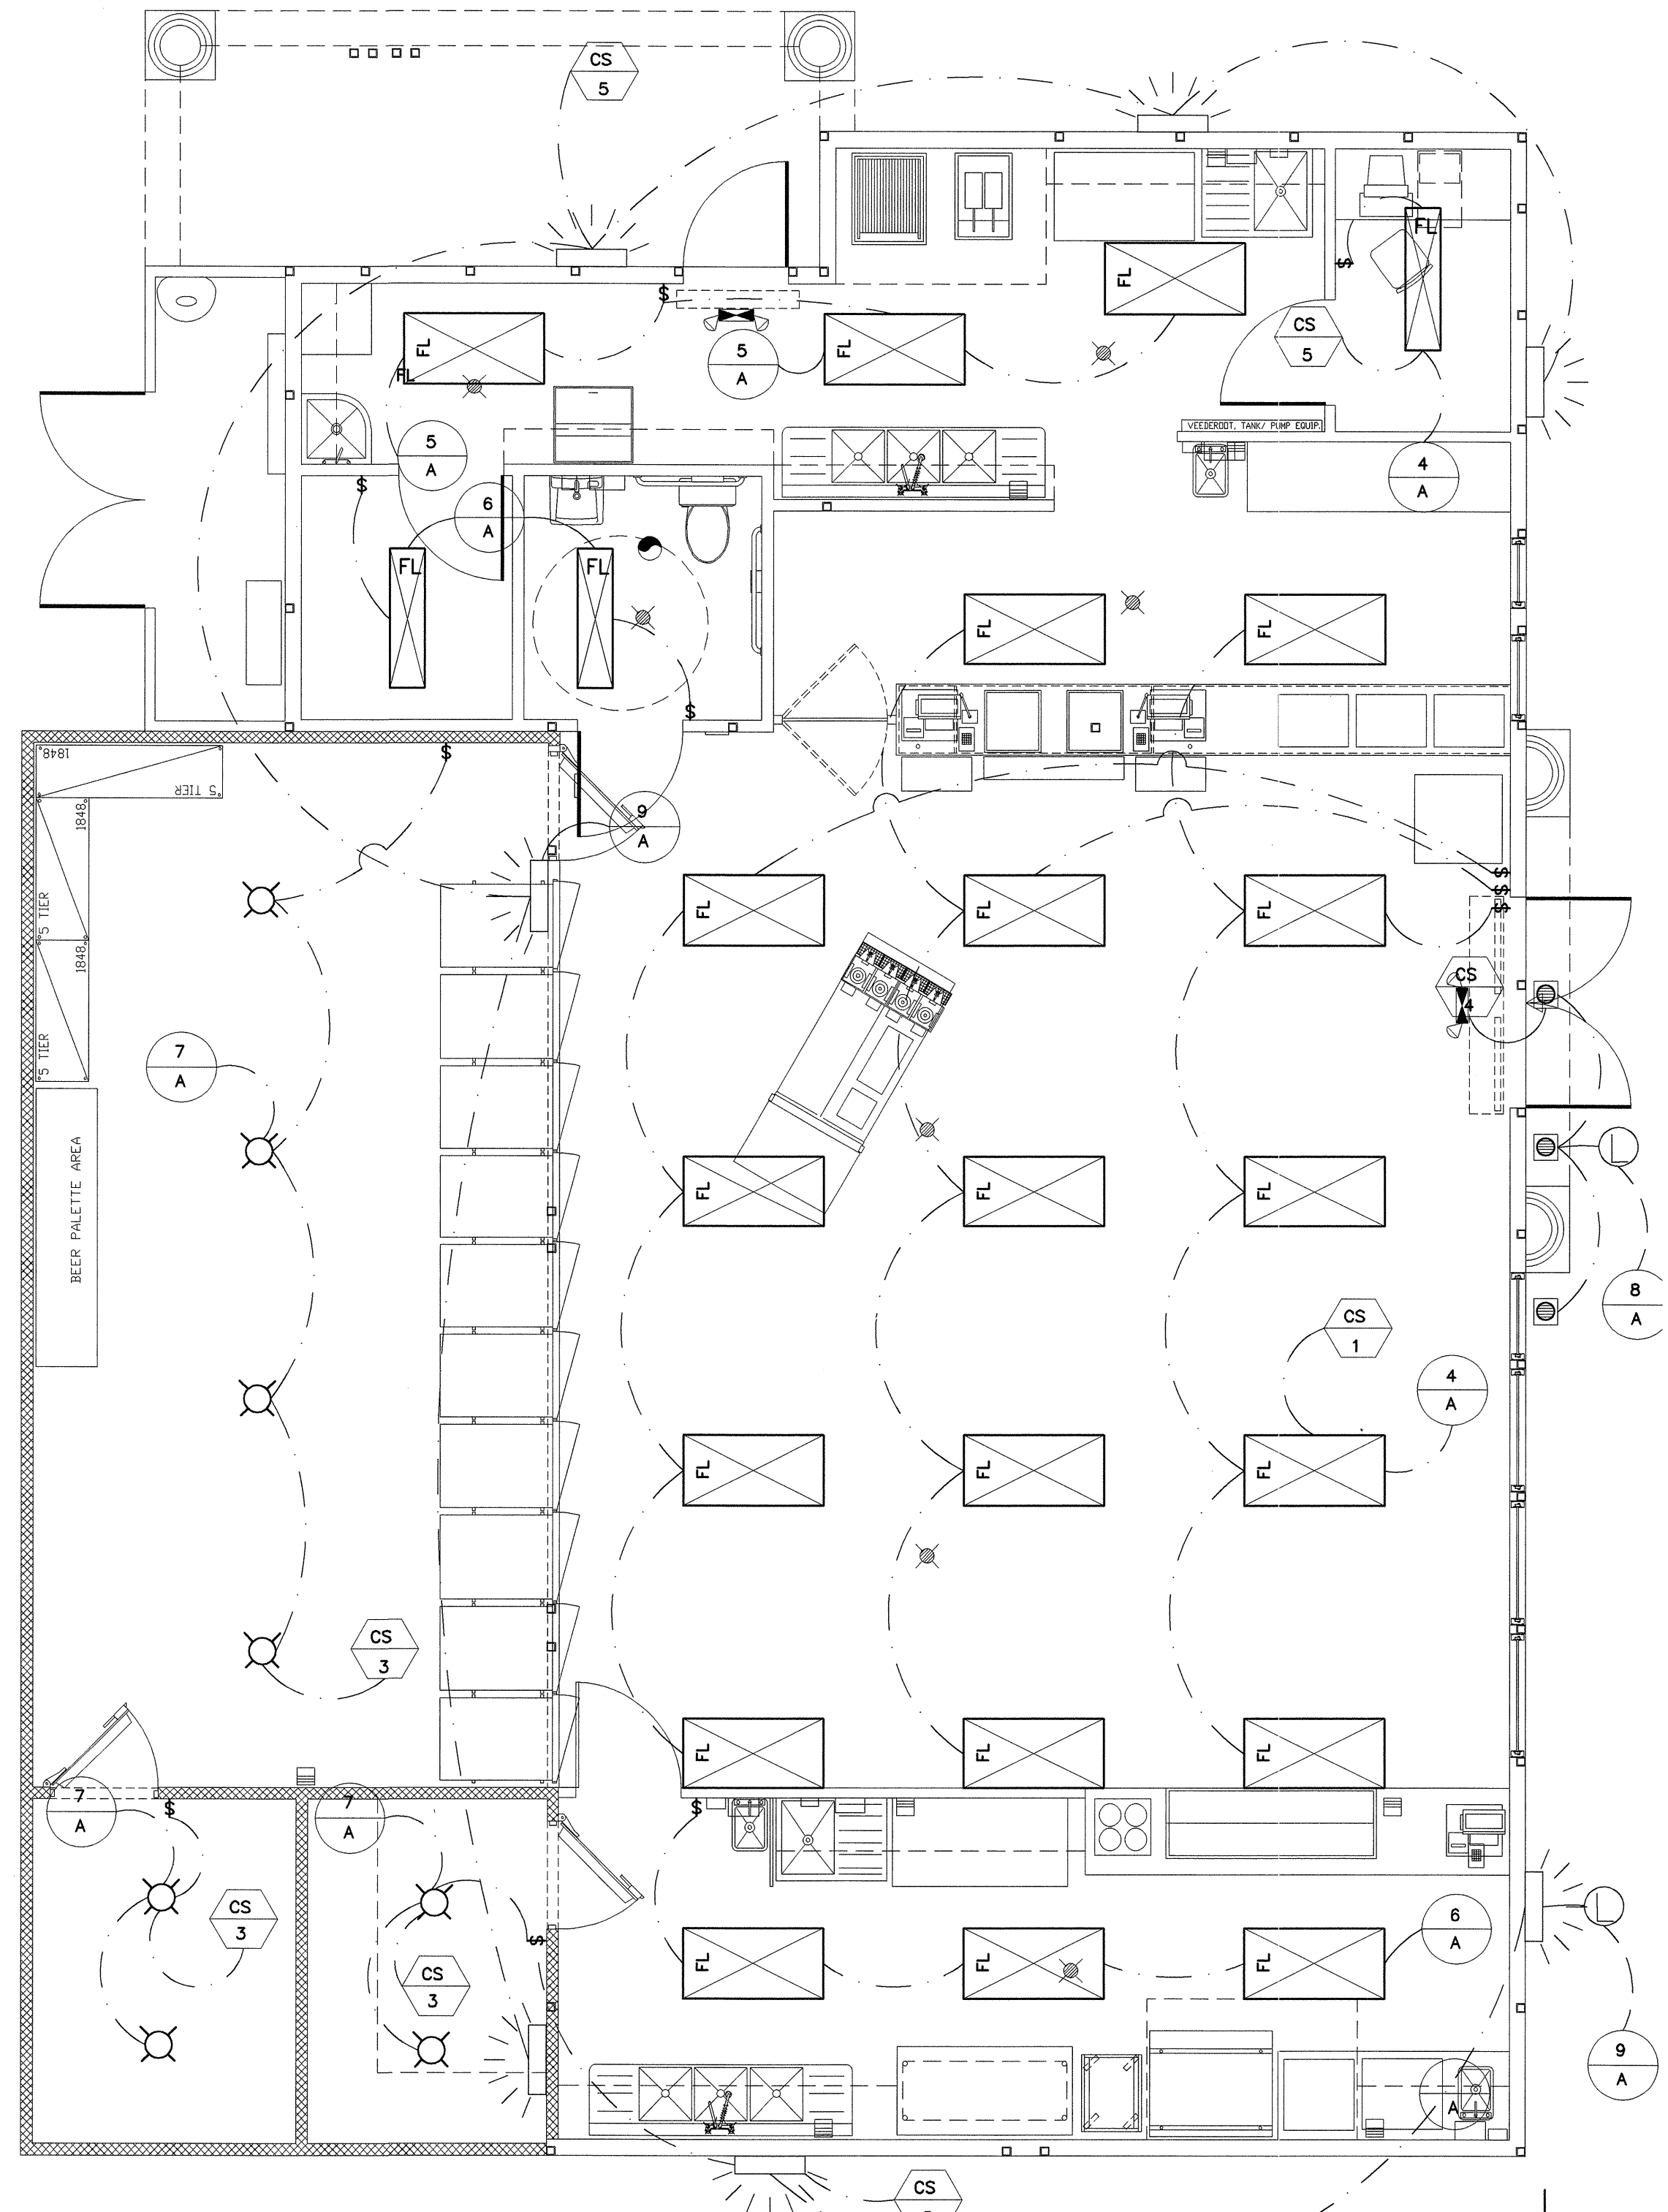


LIGHTING PLAN

POWER AND SIGN PLAN NOTES

1. EXHAUST HOOD FAN ON ROOF: 120V., 1PH., 1/3 HP., 5.4 FLA.
2. SUPPLY AIR FAN ON ROOF: 120V., 1PH., 1/3 HP., 5.4 FLA.
3. CONNECT REMOTE CONDENSER FEEDER TO ICE MAKER CIRCUIT.
4. FAN CIRCUIT "THROUGH" STARTER IN EXHAUST SYSTEM WIRING INTERLOCK BOX FURNISHED BY EXHAUST HOODS SUPPLIER.
5. CONNECT FANS SWITCH, FURNISHED WITH HOOD, TO EXHAUST SYSTEM INTERLOCK BOX SEE MANUFACTURERS CONTROL WIRING DIAGRAM.
6. WALK IN COOLER COIL/FAN UNIT: 120V., 1PH., 4.2 FLA.
7. DUCT MOUNTED SMOKE DETECTOR FURNISHED AND INSTALLED BY M.C. WIRING AND CONNECTIONS BY E.C. WIRE SMOKE DETECTORS TO AUDIBLE/VISIBLE DEVICE IN RESTROOMS
8. WALK-IN FREEZER COIL/FAN UNIT: 1PH., 10.9 FLA.
9. ISOLATED BROUND TYPE ORANGE RECEPTACLE(S)
10. C.C. SHALL PROVIDE 4X4 J-BOX WITH SINGLE GANG PLASTER RING AND WIRING CORD, PLUG, AND DRECEPTACLE FURNISHED BY OWNER, INSTALLED BY E.C.
11. EXHAUST SYSTEM WIRE INTERLOCK BOX. REF. MANUFACTURERS CONTROL WIRING DIAGRAM
12. FIRE SUPPRESSION SYSTEM CONTROL BOX.
13. TELEPHONE INTERFACE BOX. MOUNT ON WALL BELOW CEILING ABOVE PANELS
14. 12"HX14"WX4"D JUNCTION BOX W/ACCESSIBLE COVER. MAX OF (4) 3" CONDUITS FROM STALL MENUS, (1) 1" CONDUIT FROM D-T ORDER BOARD. E.C. TO INSTALL (1) 2 CONDUIT AND (2) 1" CONDUITS FROM BOX TO ABOVE CEILING. ALL CONDUIT TO BE PVC. ONLY
15. DEDICATED PHONE LINE FOR COMPUTER MODEM. RED COVER PLATE "COMPUTERS ONLY"
16. OUTDOOR LIGHTING CONTROLS.
17. E.C. TO PROVIDE 4X4 BOX W/DOUBLE PLASTER RING PLUG/CORD AND RECEP. PROVIDED WITH EQUIPMENT.

REV DATE/DESC

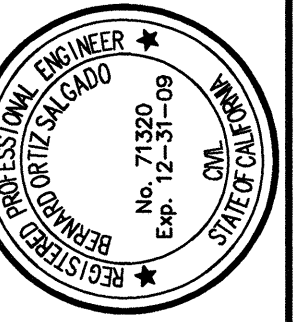

THESE PLANS PREPARED UNDER THE DIRECT SUPERVISION OF  
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SCALE: AS NOTED  
DRAWN: AA/LJF  
JOB NO: 0734

E-20