


# REFLECTED CEILING PLAN

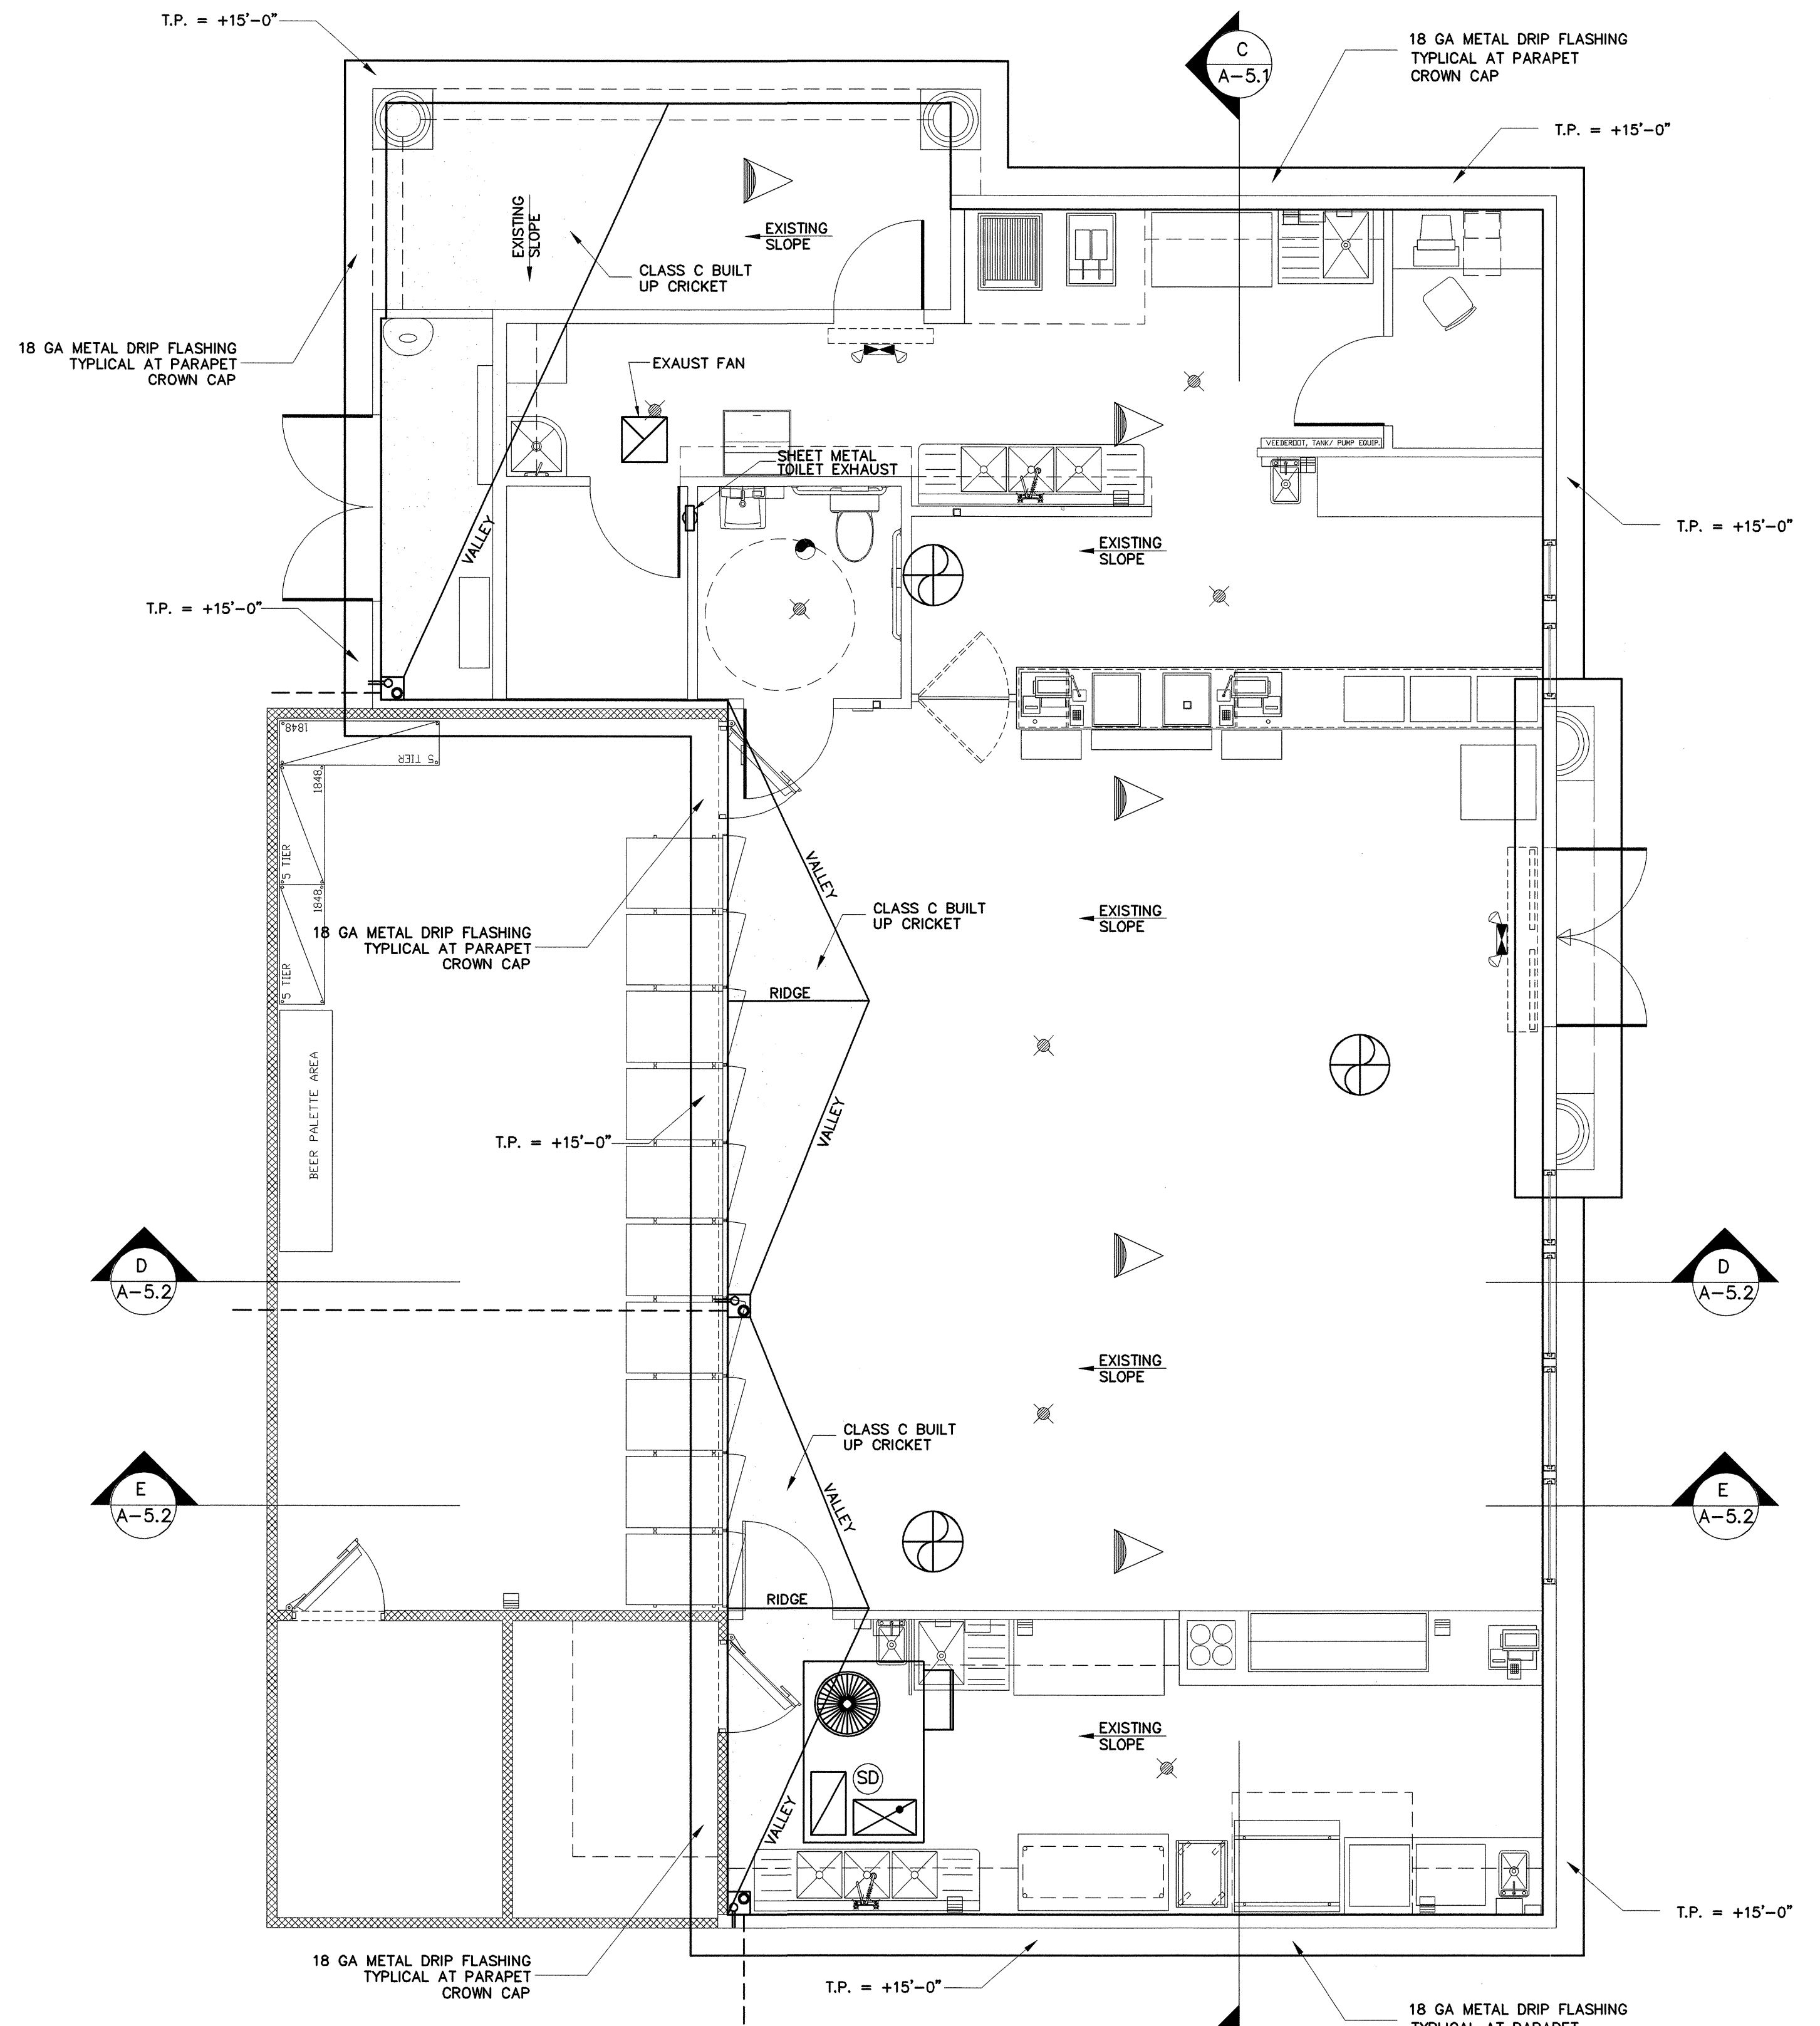

SCALE: 1/4" = 1'



## VENT SCHEDULE

- 3.14 SQ. FT. 24" WHIRLY BIRD.
- .785 SQ. FT. 12" DORMER

## ROOF NOTES

- RAIN WATER PIPING SHALL BE SCHEDULE 40 ABS DWV OR SCHEDULE 40 PVE DWV.
- ROOF DRAIN SHALL BE CAST IRON. SEE DETAIL 6 ON SHEET A-4.0
- ROOFING MATERIAL SHALL BE CLASS C TYPE ROOF WITH A MINIMUM SLOPE OF 1/4" PER 1'.

## ATTIC VENT CALCULATIONS

VENTILATION REQUIRED = 1,676 SF/150 = 11.17 SF

24" HALF ROUND VENT = 0.75 SF(5) = 3.75

24" WHIRLY BIRD = 3.14 SF(3) = 9.42


TOTAL REQUIRED = 11.17 < 13.17 PROVIDED = OK



SCALE: 1/4" = 1'

# ROOF PLAN

REV	DATE/DESC

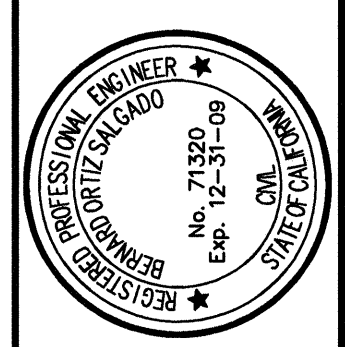

THESE PLANS PREPARED UNDER THE DIRECT SUPERVISION OF

*[Signature]*

BENIGNO O. SALGADO RCE 71320

1129 Union Avenue  
Bakersfield, Ca

## Reflected Ceiling Plan/ Roof Plan

**Afinar**  
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DATE: 03-26-09  
SCALE: AS NOTED  
DRAWN: AA/LJF  
JOB NO: 0734

A-40