


'-**Architect** (661) 324-5252 FAX (661) 324-8439

DOOR SCHEDULE - WINDOW SCHEDULE - NOTES
PROPOSED CONVENIENCE
WILLIES MARKET
690 N ELMWOOD AVE
LINDSAY, CA

JOB NO. C09 - 057

SHEET NO.

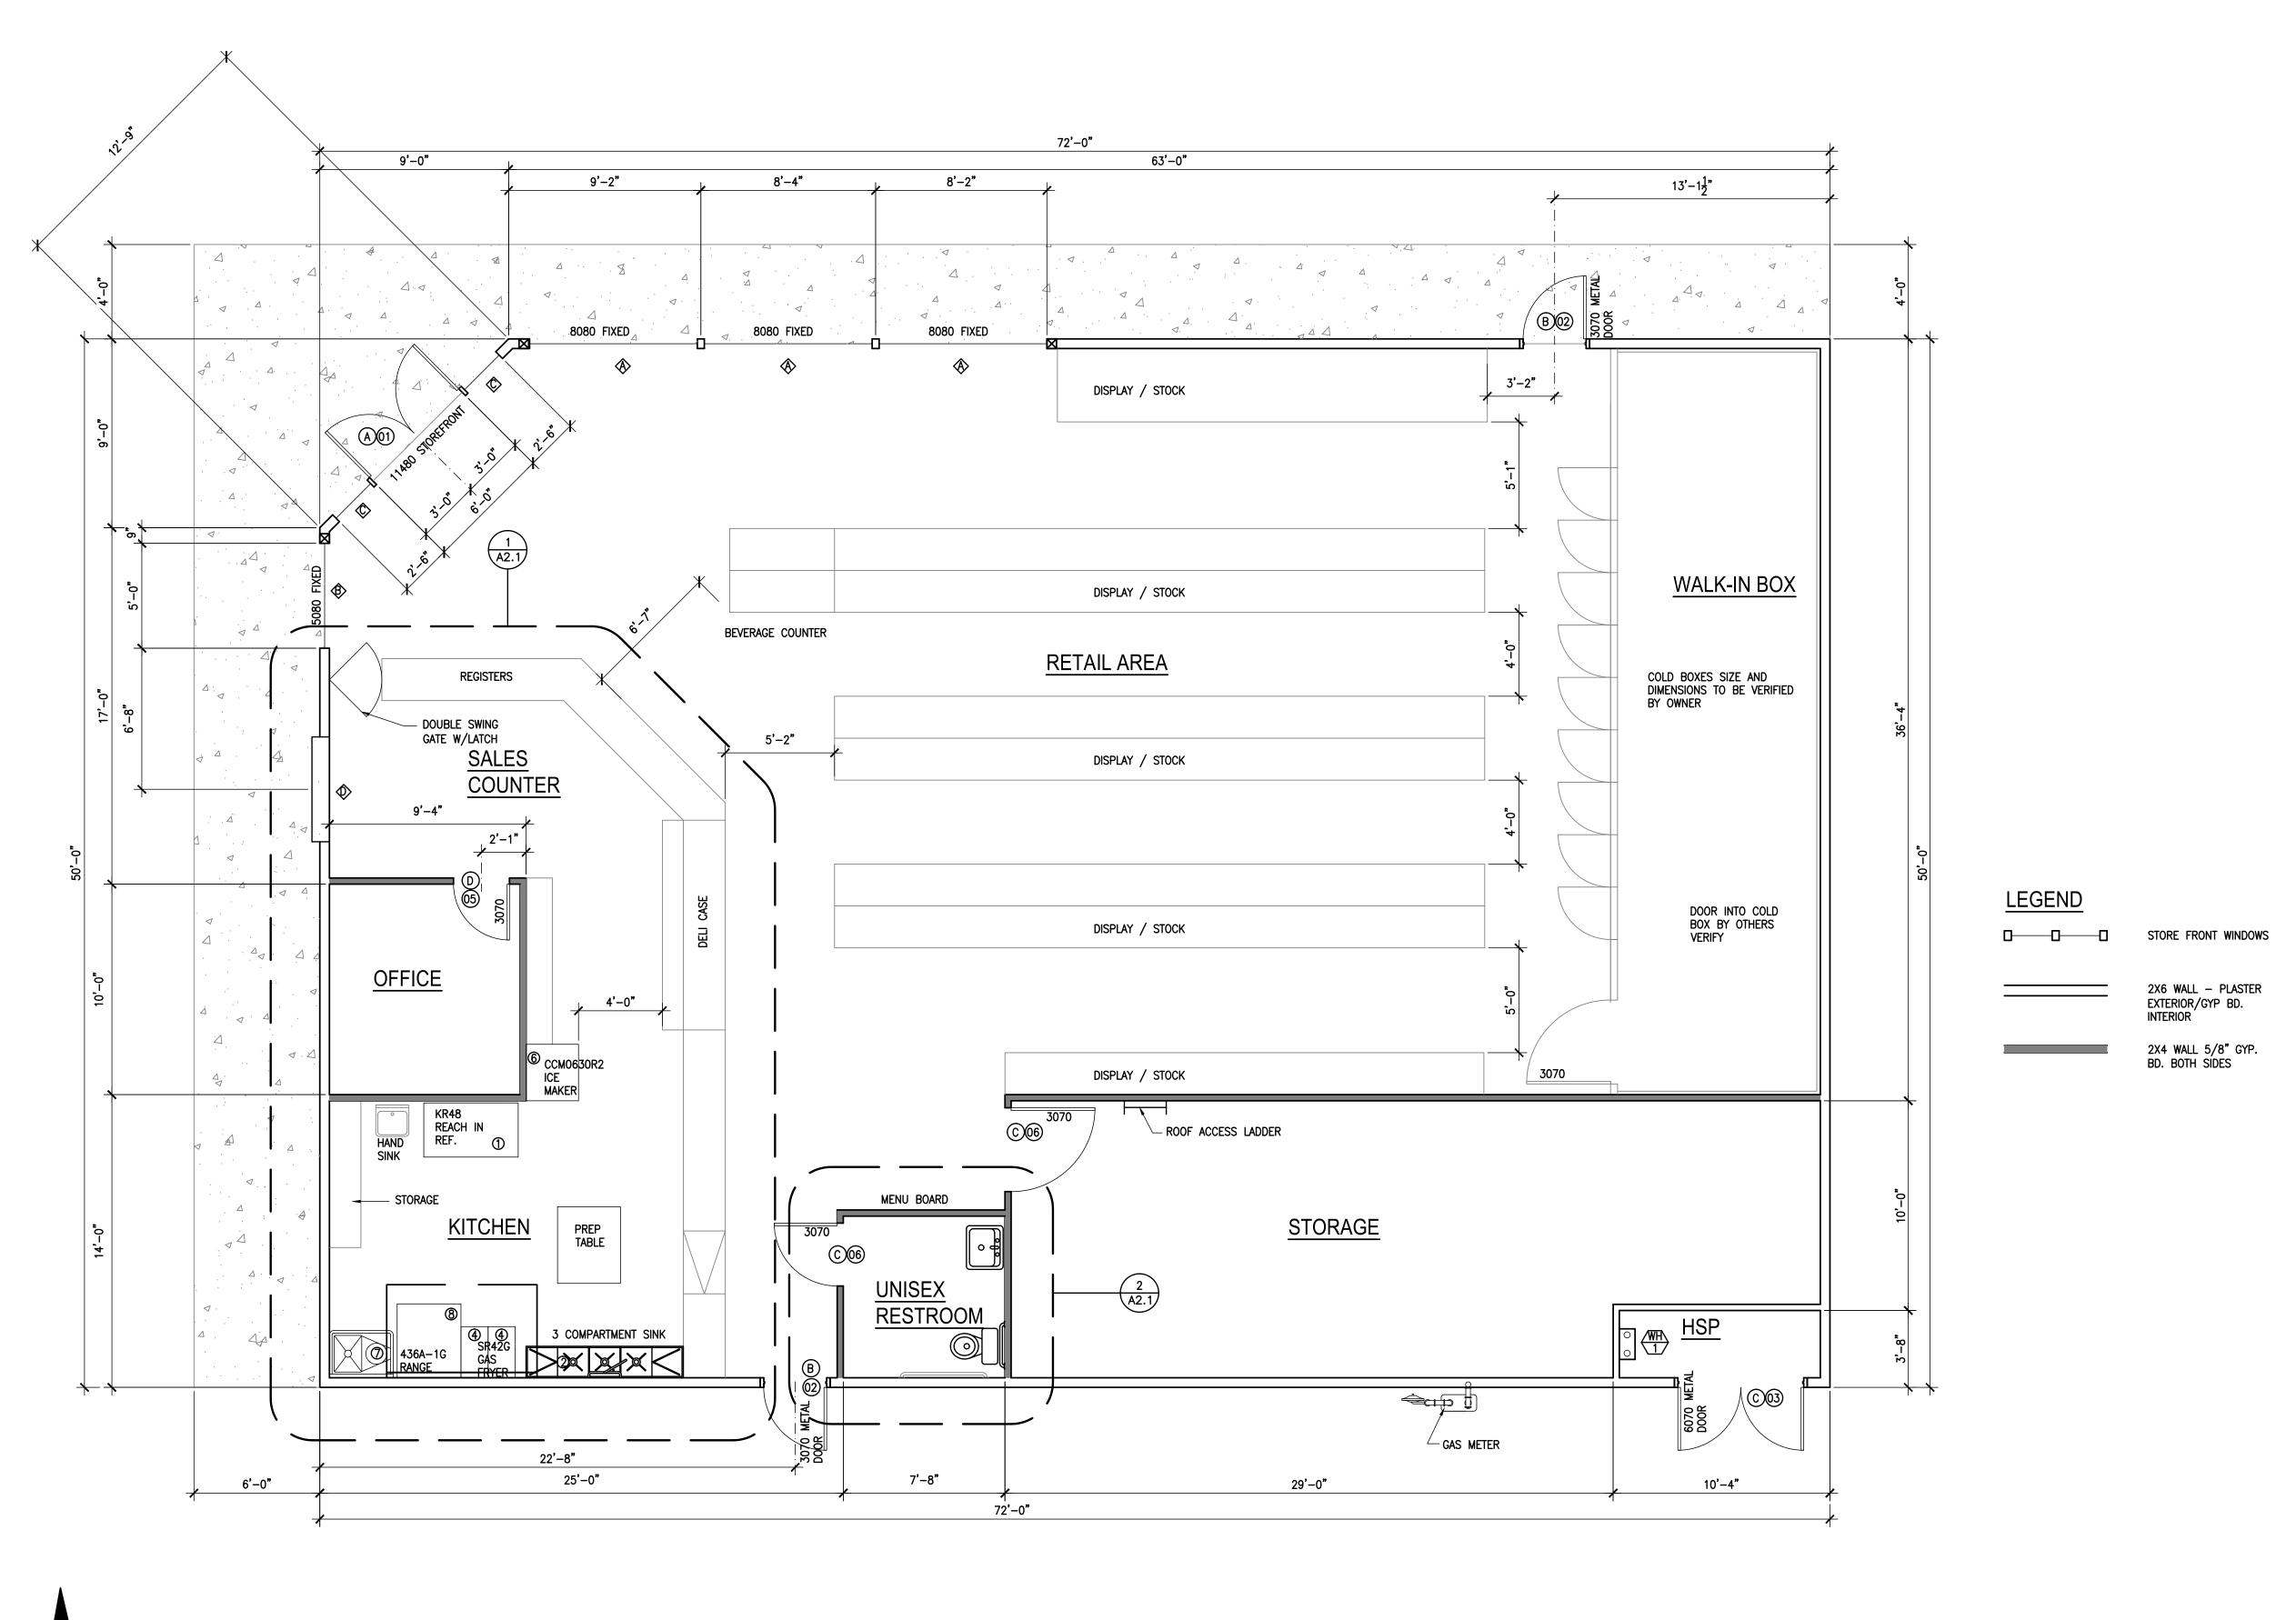

FLOOR PLAN

C09-057 SHEET NO.

JOB NO.

FOR:


STORE


FLOOR PLAN

PROPOSED CONVENIENCE :

WILLIES MARKET

690 N ELMWOOD AVE
LINDSAY CA

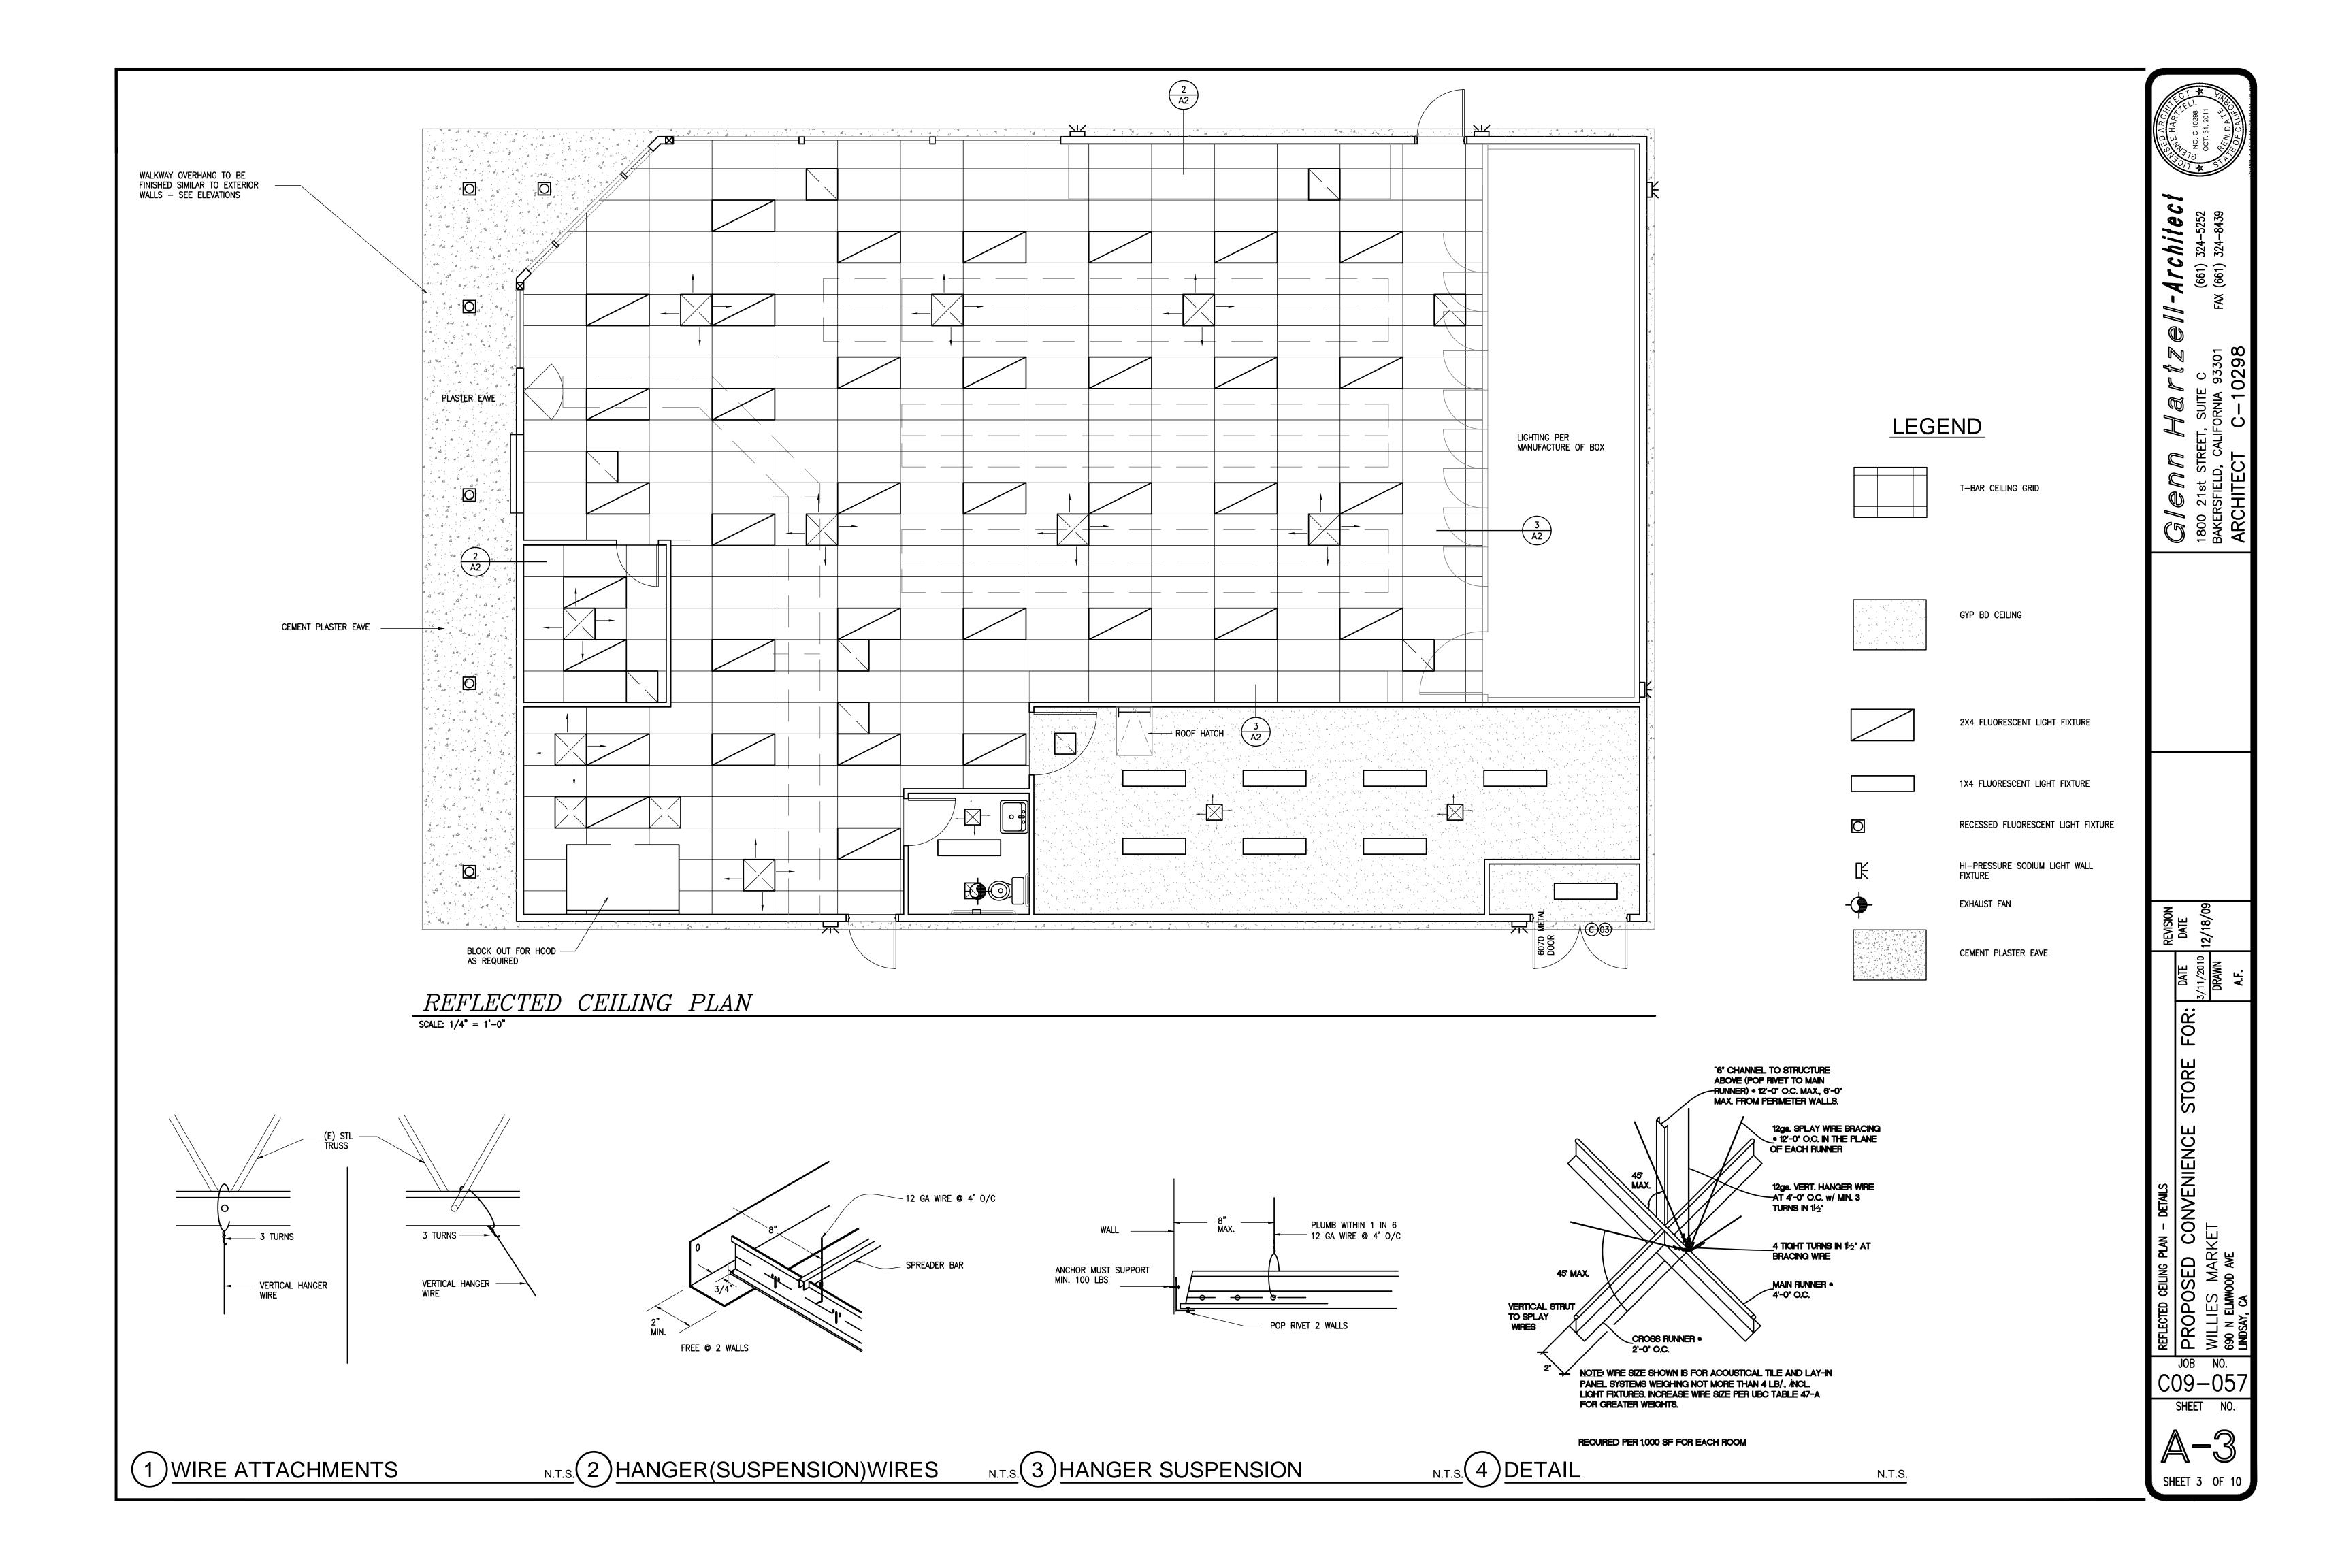

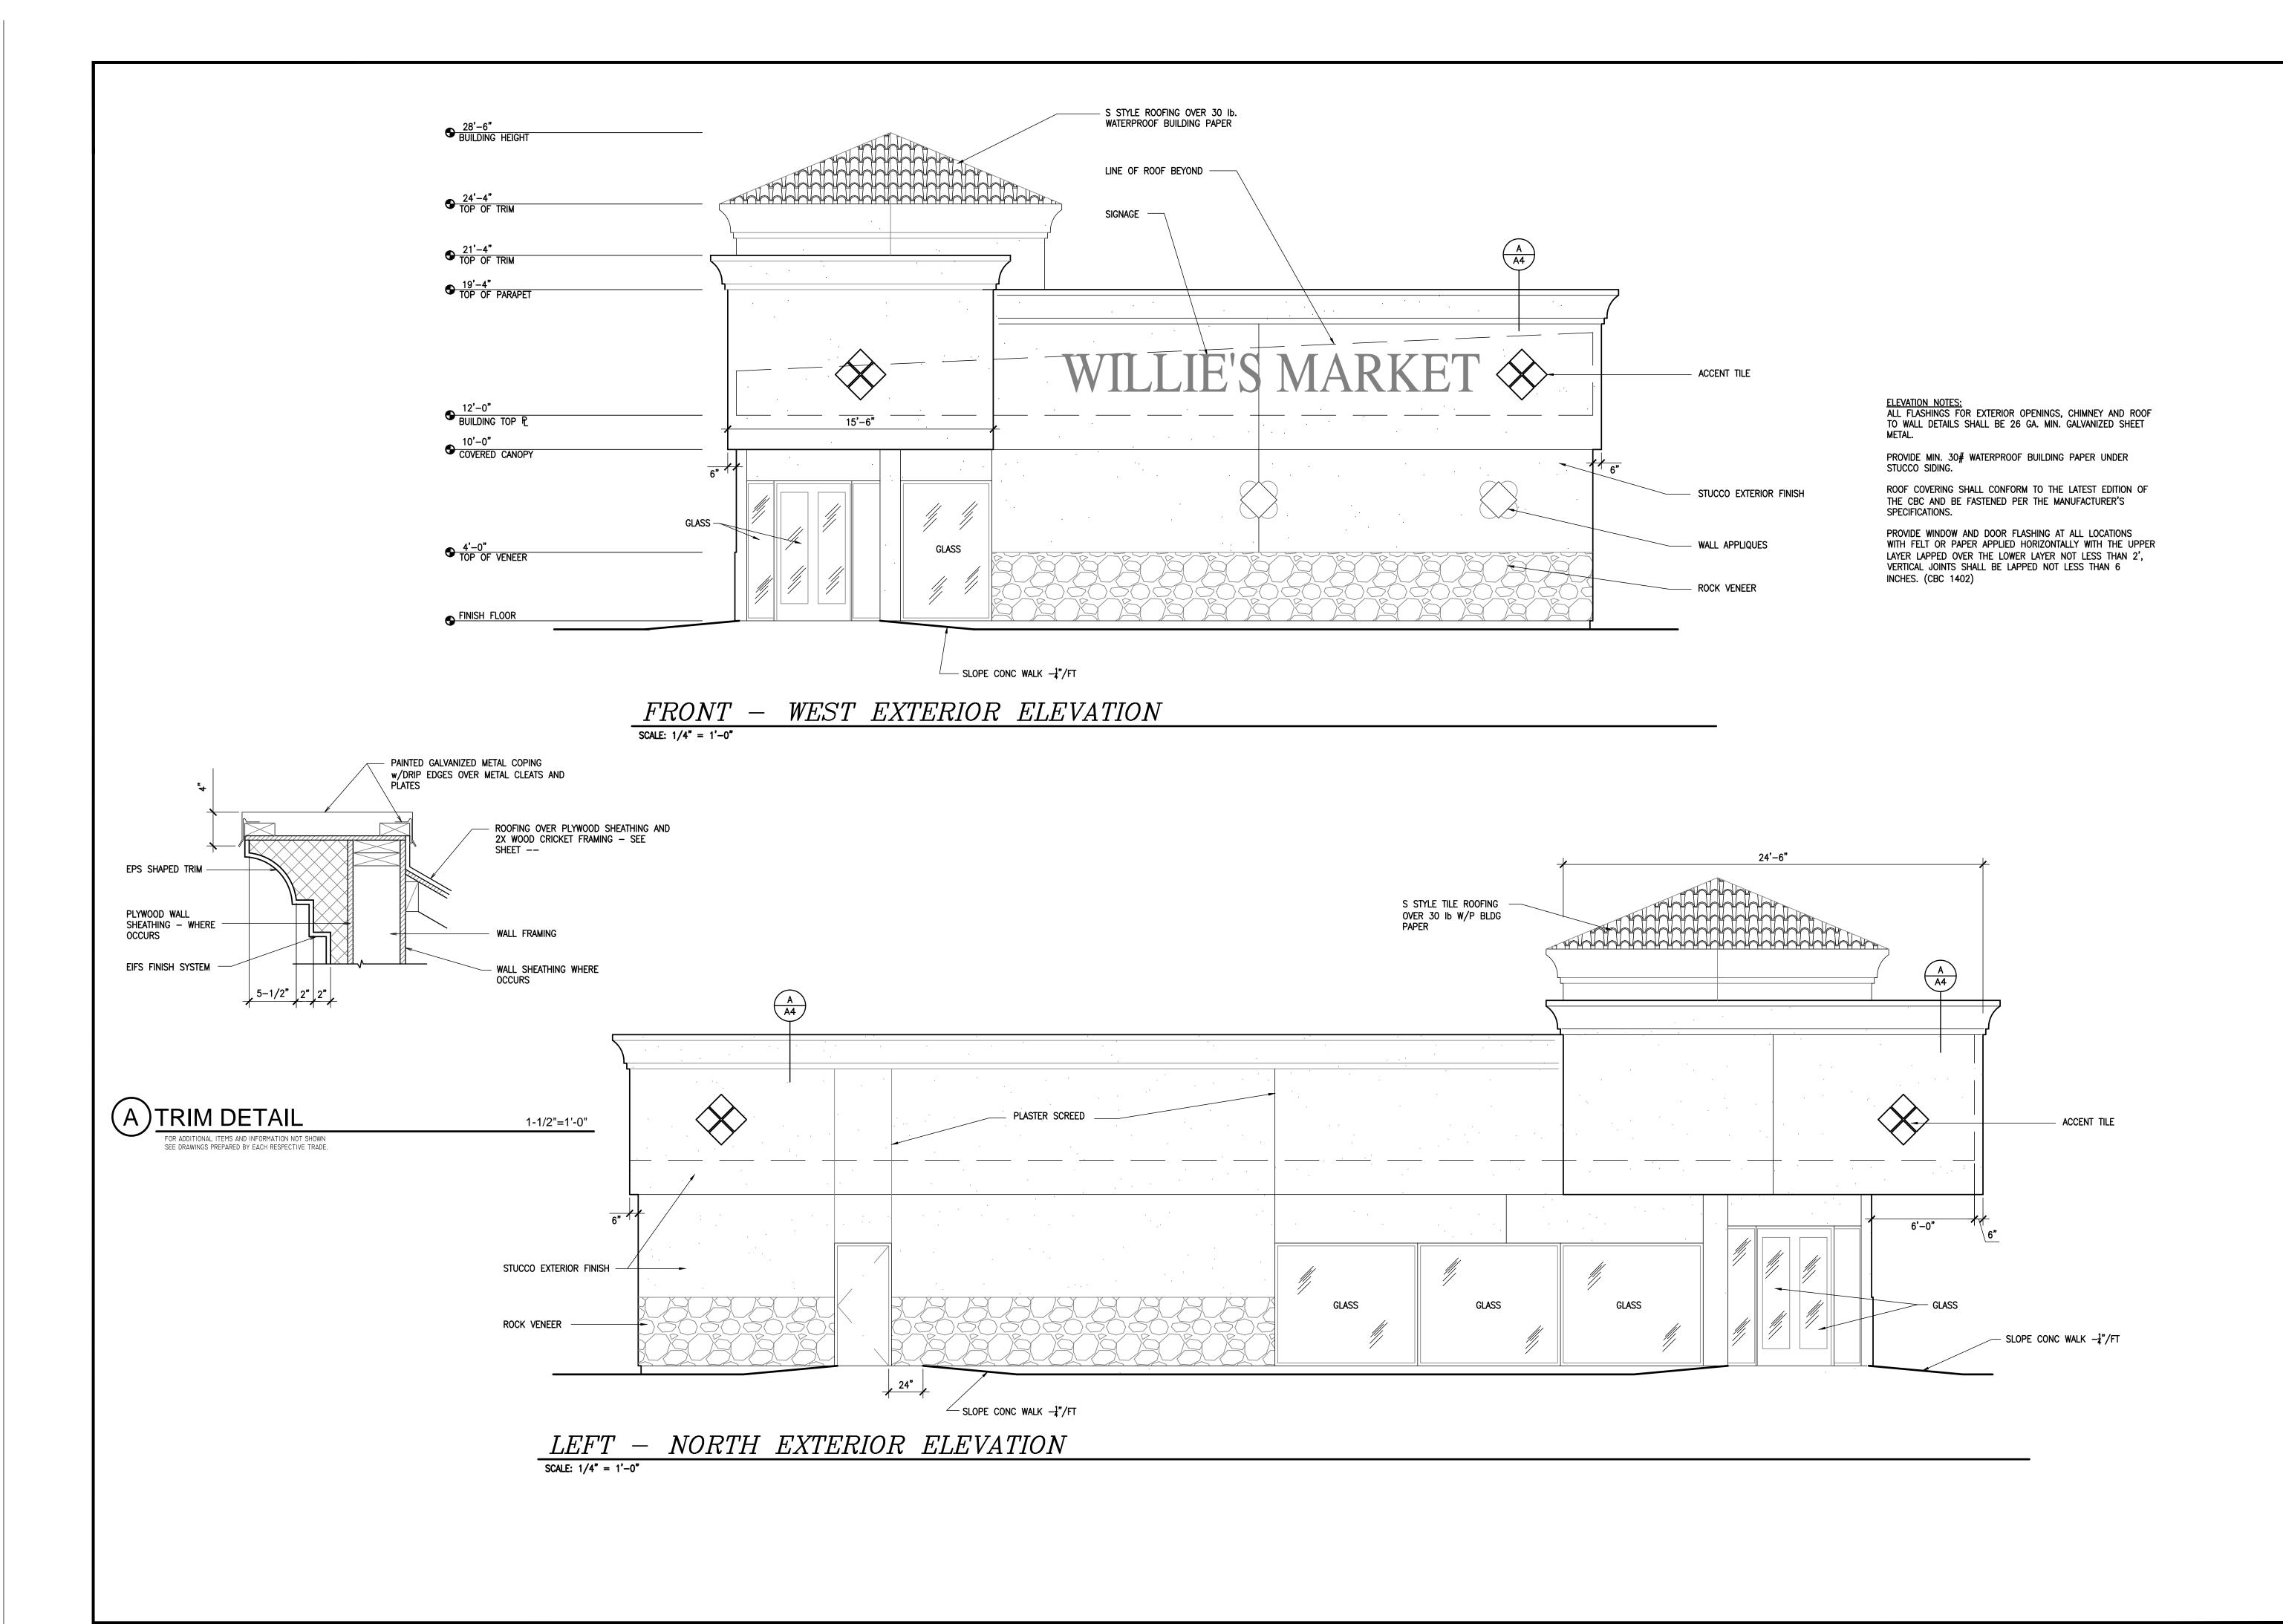

A OCT. 31, 2011

A CALIFORNIA

OCT. 31, 2011

A CALIFORNIA

OF CALIFORNIA

DATE DATE 12/18/09 RAWN

ONVENIENCE STORE FOR:

EXTERIOR ELEVATIONS – DETAILS


PROPOSED CONVENIENCE


WILLIES MARKET

690 N ELMWOOD AVE

JOB NO.
CO9-05
SHEET NO.

SHEET 4 OF 10

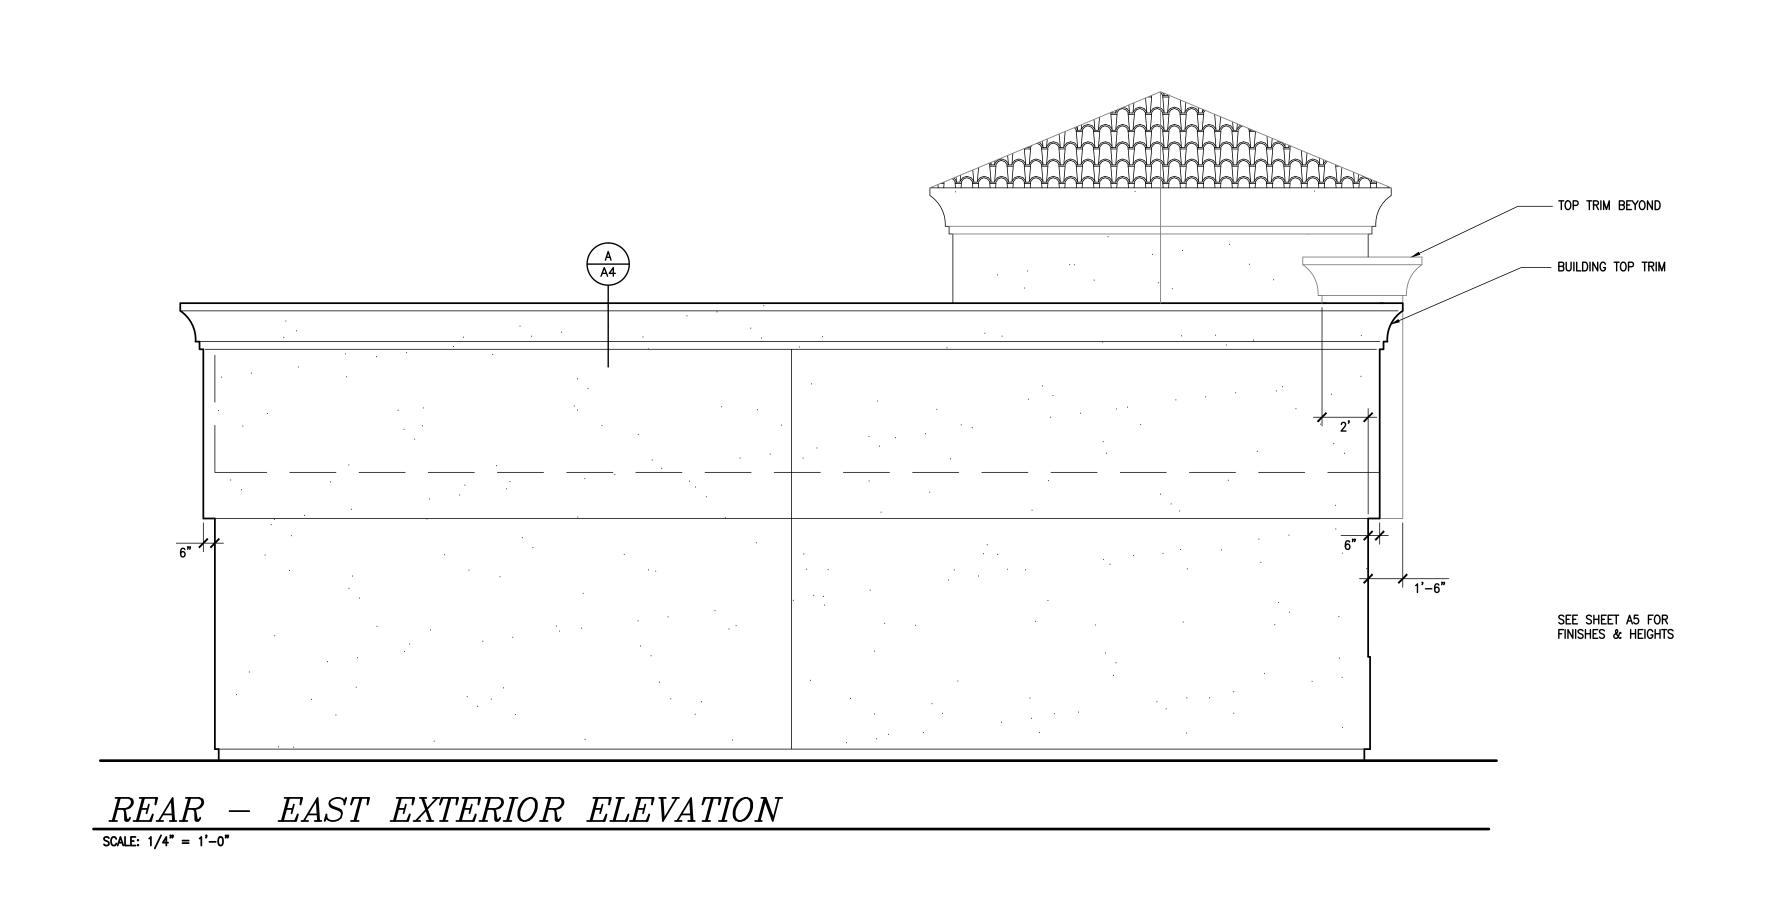

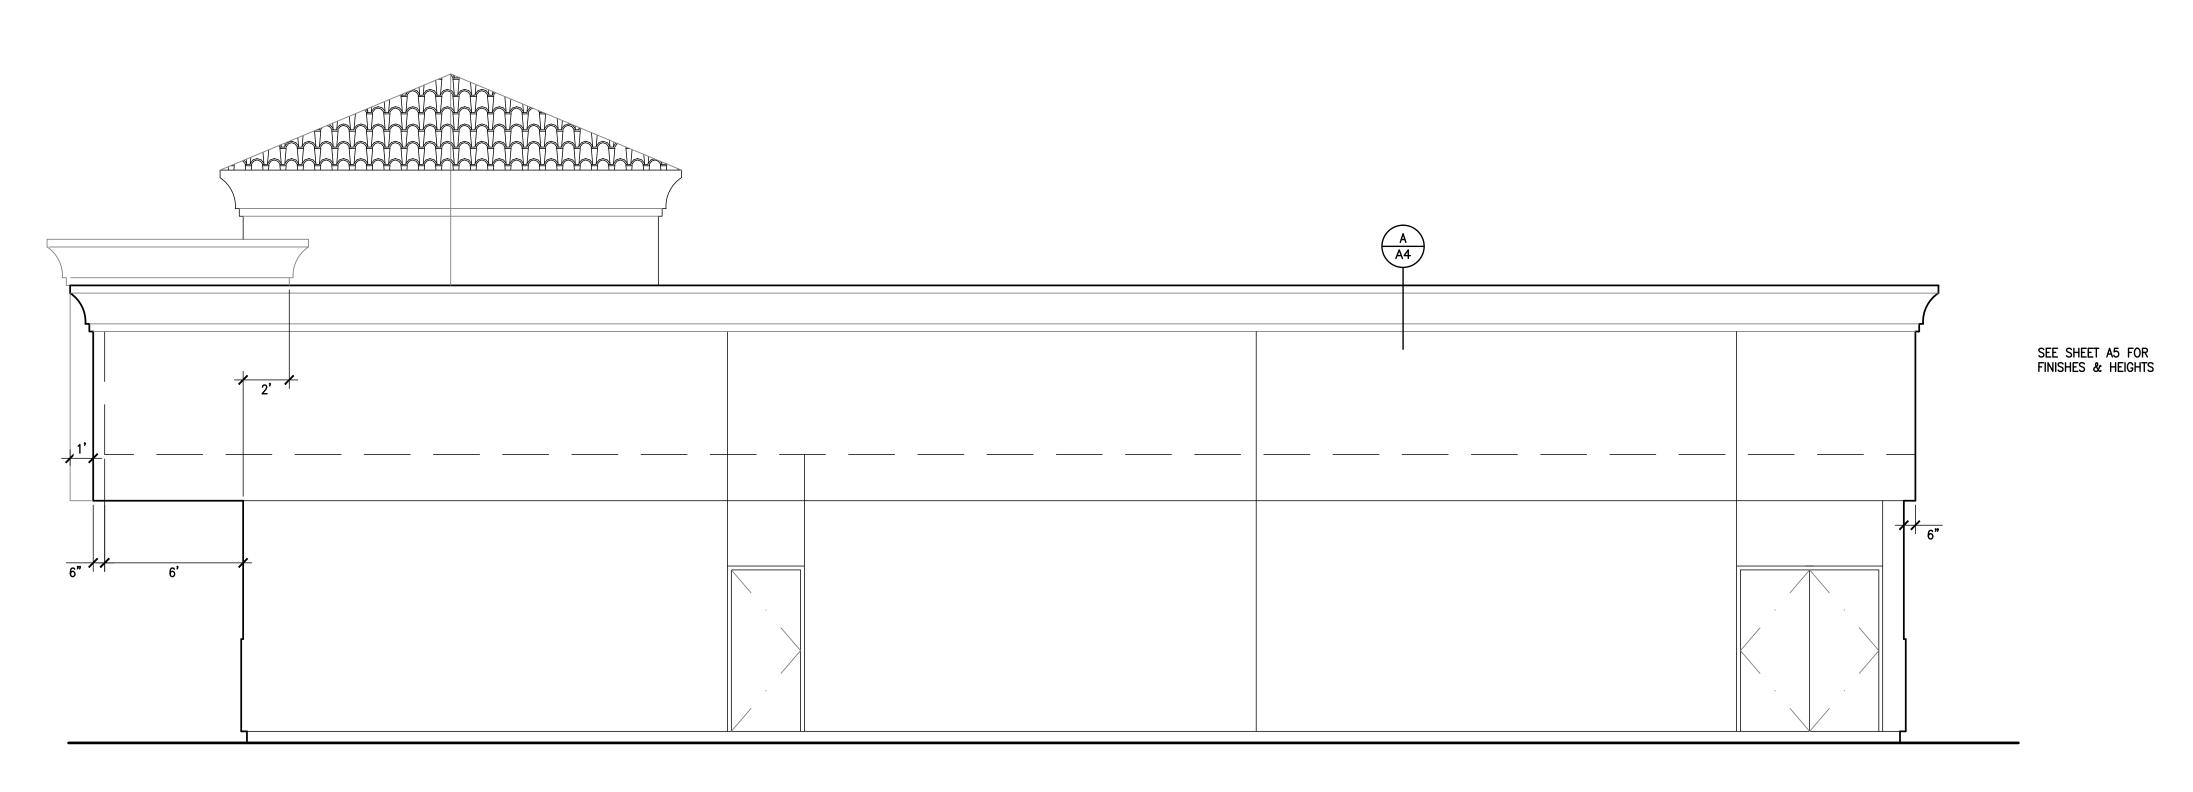

RIGHT - SOUTH EXTERIOR ELEVATION

SCALE: 1/4" = 1'-0"

COLUMBATA DATE OF CAUE OF CAUE

DATE DATE

/11/2010

DRAWN

REVISION

12/18/09

ED CONVENIENCE STORE FOR:

EXTERIOR ELEVATION


PROPOSED C

WILLIES MARKE

SO N FIMMOD AVE


JOB NO. CO9-057 SHEET NO.


A-5
SHEET 5 OF 10

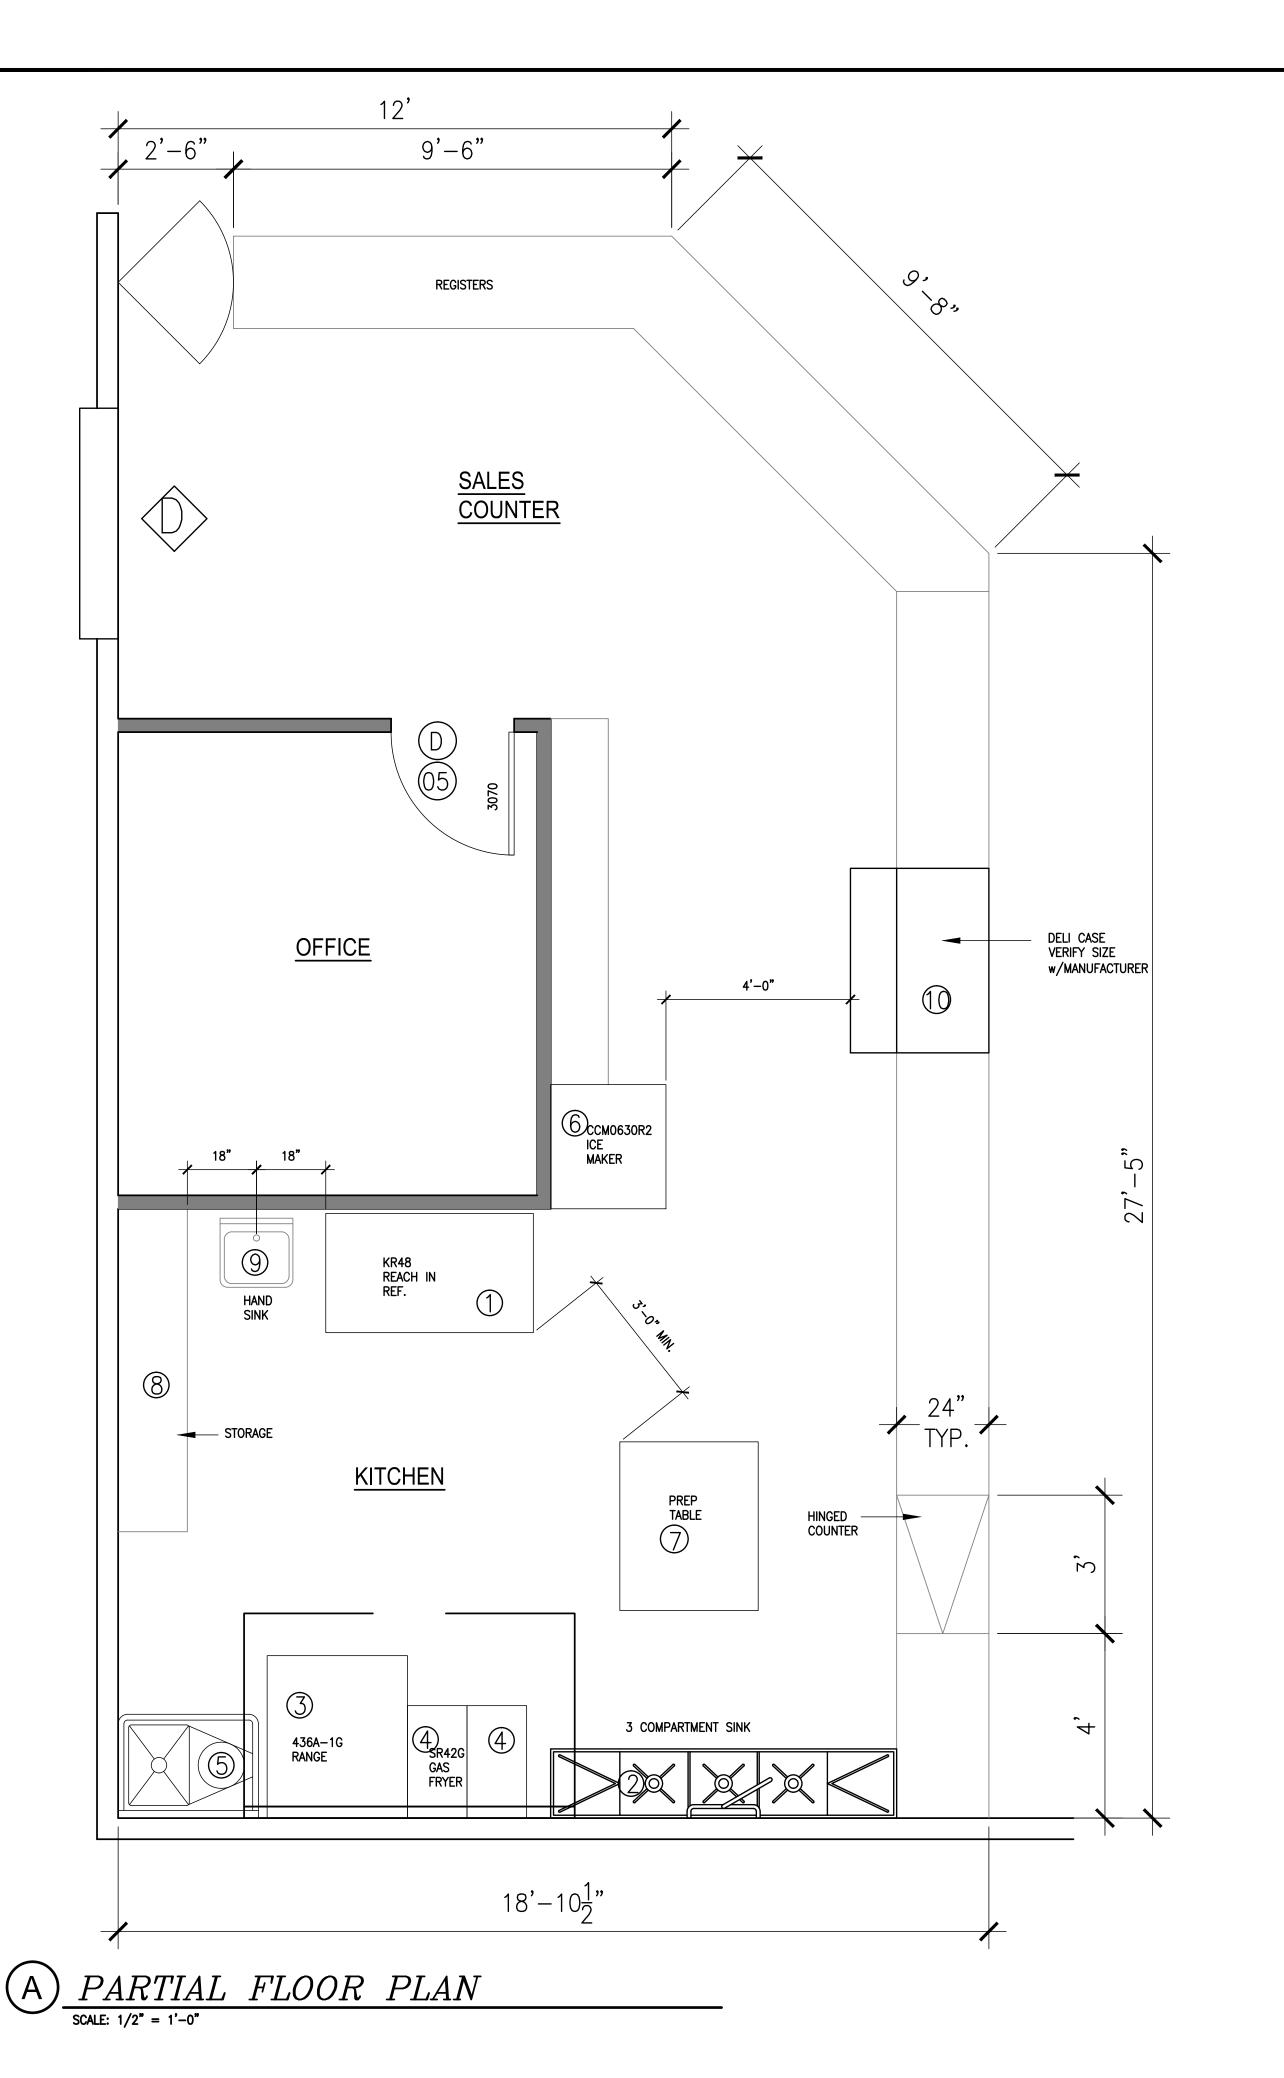

### EQUIPMENT LIST

MARK	MODEL	EQUIPMENT NAME	ELECTRICAL	GAS	WATER
1	CARRIER KR48	CARRIER KR48	115V 7A		
(2)	EAGLE 414-16-3-18	3 COMPARTMENT SINK	_		½" CW/HW
(3)	SOUTHBEND 436A-1G	RANGE / OVEN	115V 4.8A	3/4" GAS 196,000 BTU	
4	DEAN SR42G	DEEP FRYER		3/4" GAS 105,000 BTU	
5	NSE TSA-1-L1	PREP SINK			½" CW/HW
6	NORDIC CCMO630	ICE MAKER	208V 12.0A		½" CW/HW
7		S.S. PREP TABLE			
8		STORAGE RACKS 18"			
9		HAND SINK			
(10)	ALTO-SHAAM HN-48P	DELI UNIT	115V 20A 120V 30A		

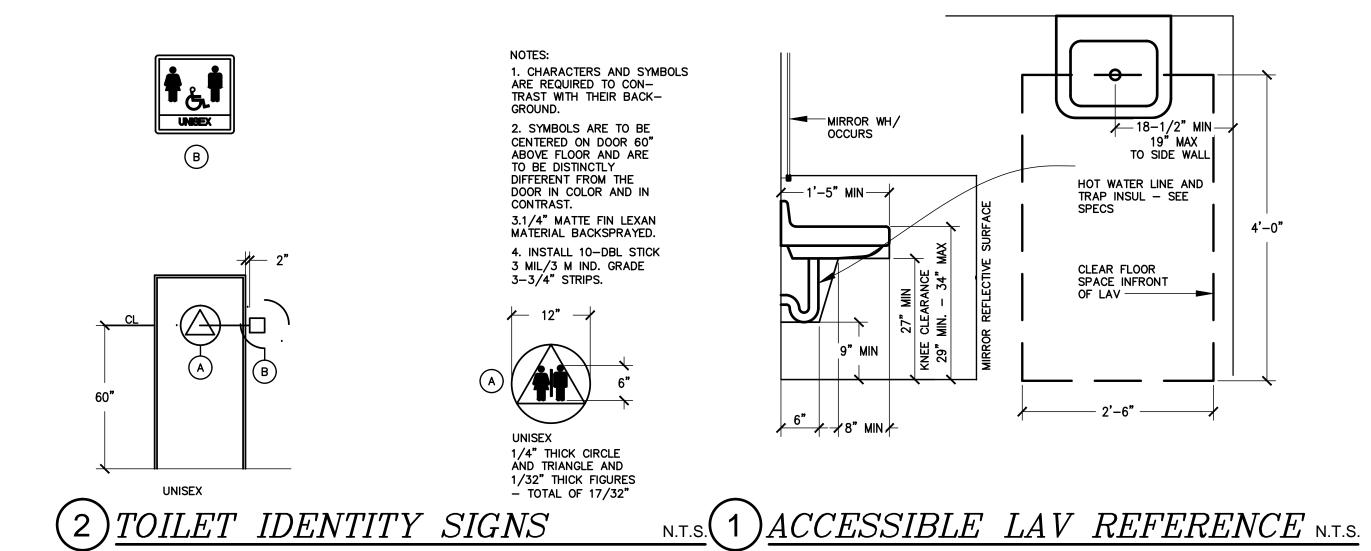

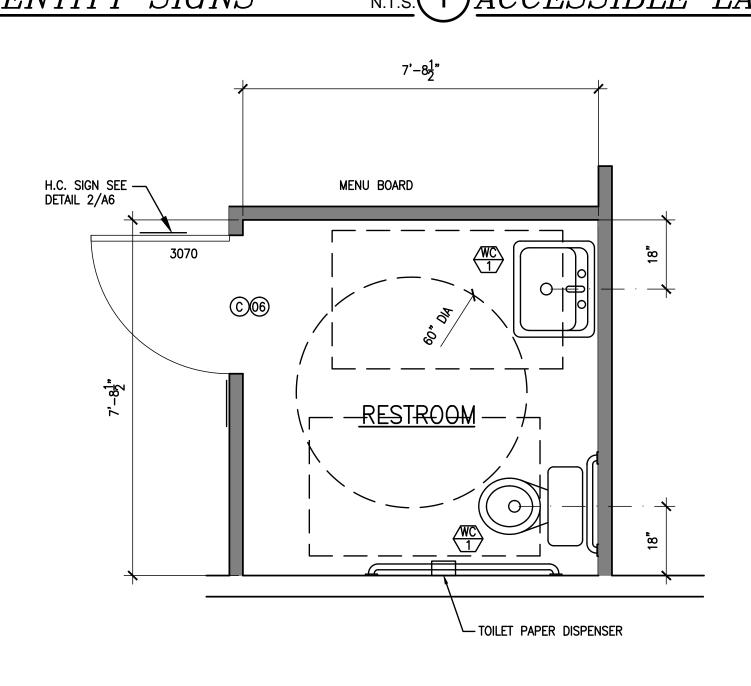

B PARTIAL FLOOR PLAN

SCALE: 1/2" = 1'-0"

CONSTRUCTION OF THE STATE OF CALIFORNIA DIAM.

H 2 F  $\ell$  2  $\ell$  1 - Architect ET, SUITE C (661) 324-5252 ALIFORNIA 93301 FAX (661) 324-8439

1800 21st STREET, SUITE (BAKERSFIELD, CALIFORNIA 9

| REVISION | DATE | DATE | 12/18/09 | |

FORE FOR: 3/11/2010 12,


PLANS - EQUIPMENT LIST


ED CONVENIENCE STORE


PARTIAL FLOOR PLANS - EQUIPMENT
PROPOSED CONVENI
WILLIES MARKET

JOB NO. CO9-057 SHEET NO.

A-6
SHEET 6 OF 10

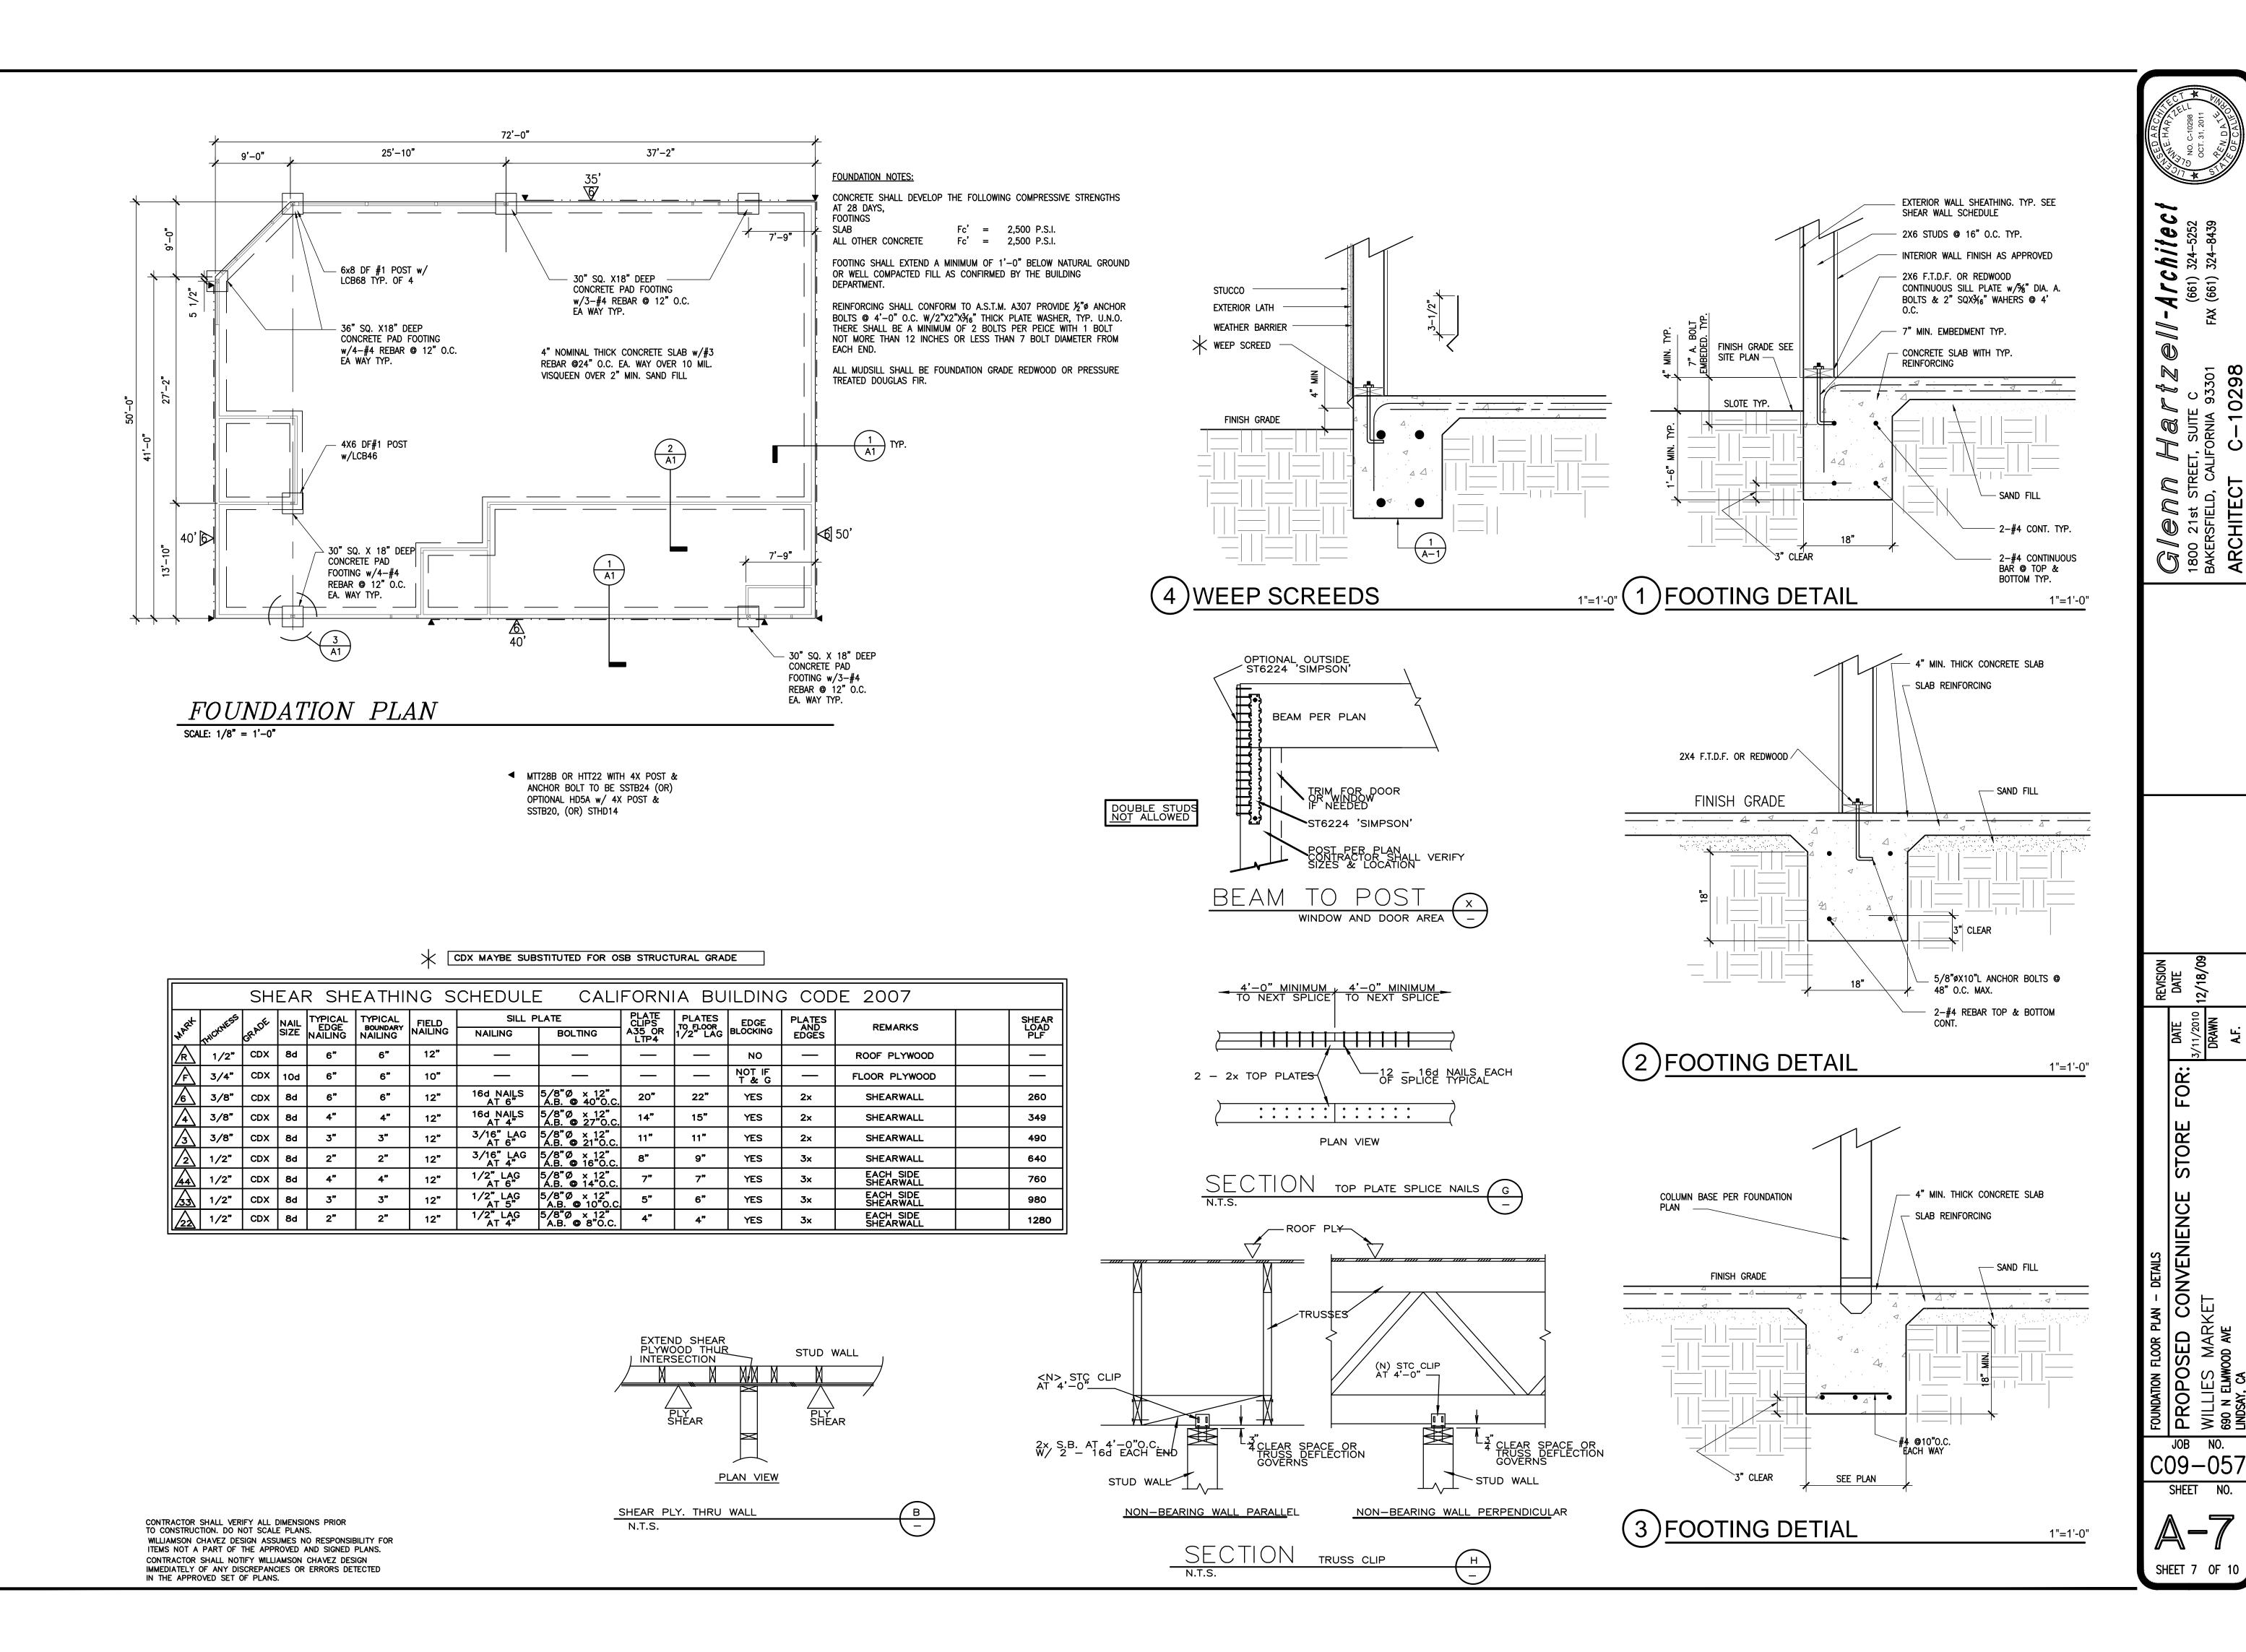

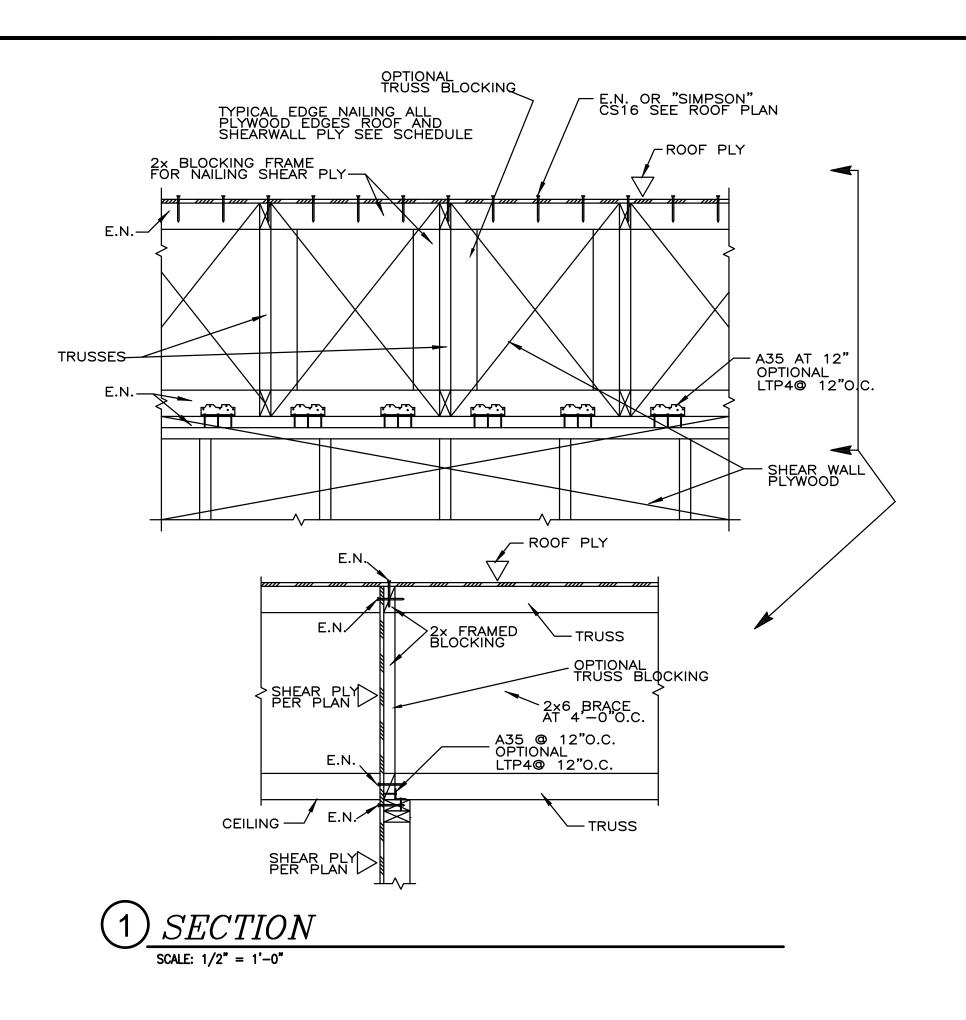

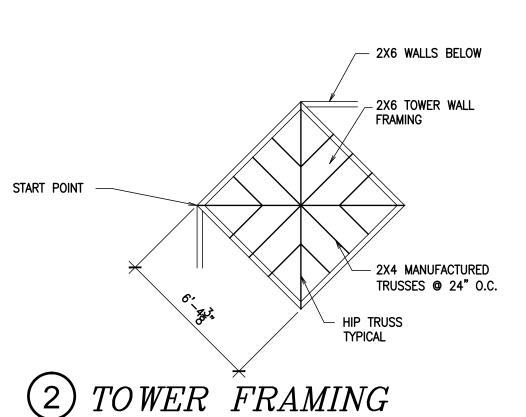


SCALE: 1/2" = 1'-0"

ROOF FRAMING NOTES:

1. SHEATH ENTIRE ROOF WITH A.P.A. RATED SHEATHING (ORIENTED STRAND BOARD OR PLYWOOD). UNLESS NOTE OTHERWISE, USE 1/2" NOMINAL THICKNESS (15/32" MINIMUM THICKNESS) USE C-D GRADE, SPAN RATING 3/16", 5 PLY. INSTALL SHEATHING WITH LONG DIMENSION PERPENDICILIAR TO JOISTS STAGGER JOINTS PERPENDICULAR TO JOISTS. STAGGER JOINTS PER ROOF FRAMING PLAN.
MANUFACTURER;S TJI ROOF JOIST ENGINEERING SHALL BE SUBMITTED TO THE BUILDING DEPARTMENT PRIOR TO INSTALLATION.

DEAD LOAD: 25 PSF LIVE LOAD: 20 PSF (REDUCIBLE TYPICAL ROOF SHEATHING NAILING (EXCEPT AS NOTED ON ROOF FRAMING PLAN).

10d @ 6" O.C. AT BUILDING PERIMETER 10d @ 6" O.C. AT PANEL EDGES 10d @ 12" O.C. FIELD NAILING TYPICAL 4. ALL NAIL CALL-OUTS ARE FOR COMMON NAILS UNLESS NOTED OTHERWISE.

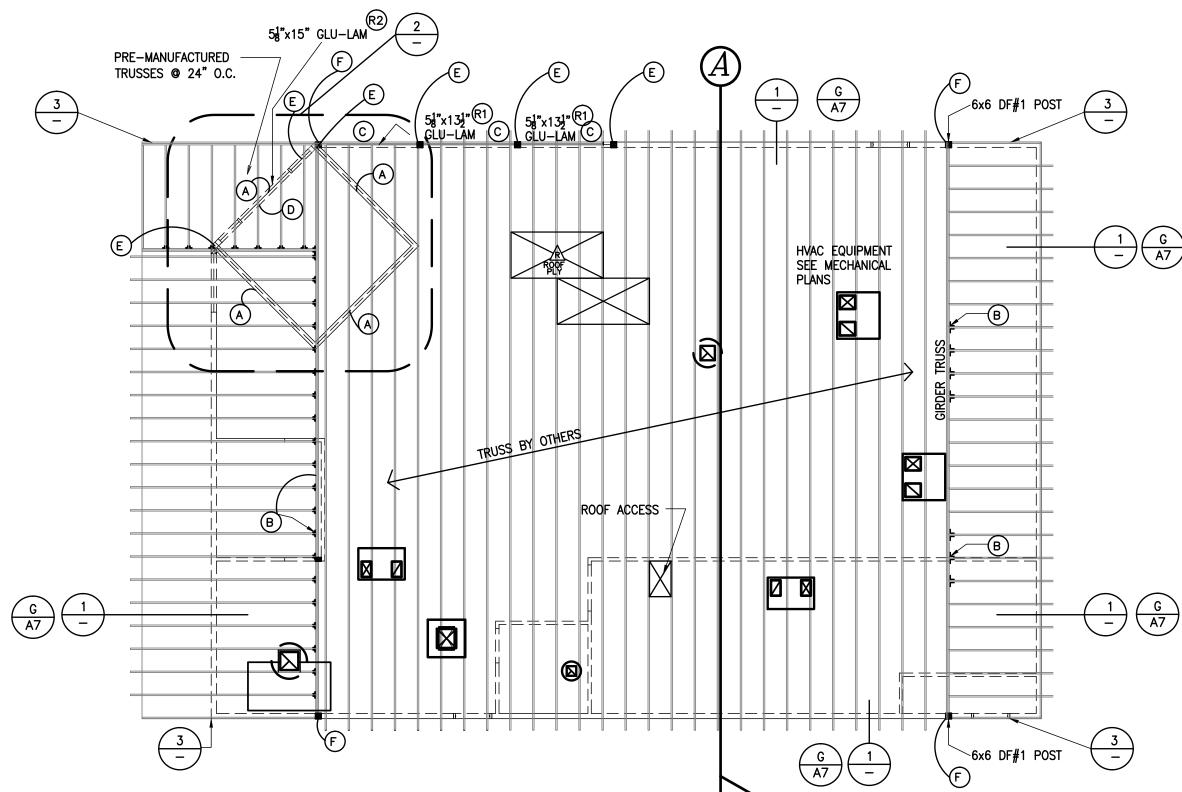

ROOF FRAMING PLAN

SCALE: 1/8" = 1'-0"

(A) 4x BLOCKING BETWEEN TRUSSES UNDER TOWER TYP.

(B) TRUSS HANGER BY TRUSS COMPANY

© 5 1/8"x13 1/2" GLU-LAM 24F-V4 W/6x6 POST  $\frac{X}{A7}$ 

D 5 1/8"x15" GLU-LAM 24F-V4 W/6x6 POST X A7


461 S. MAIN STREET, PORTERVILLE, CA 93257


MARK HILLE

TRUSS COMPANY INFO:

TRI-K TRUSS COMPANY

E 6x6 POST F 6x6 POST UNDER GIRDER TRUSS ABOVE (559) - 784 - 8511

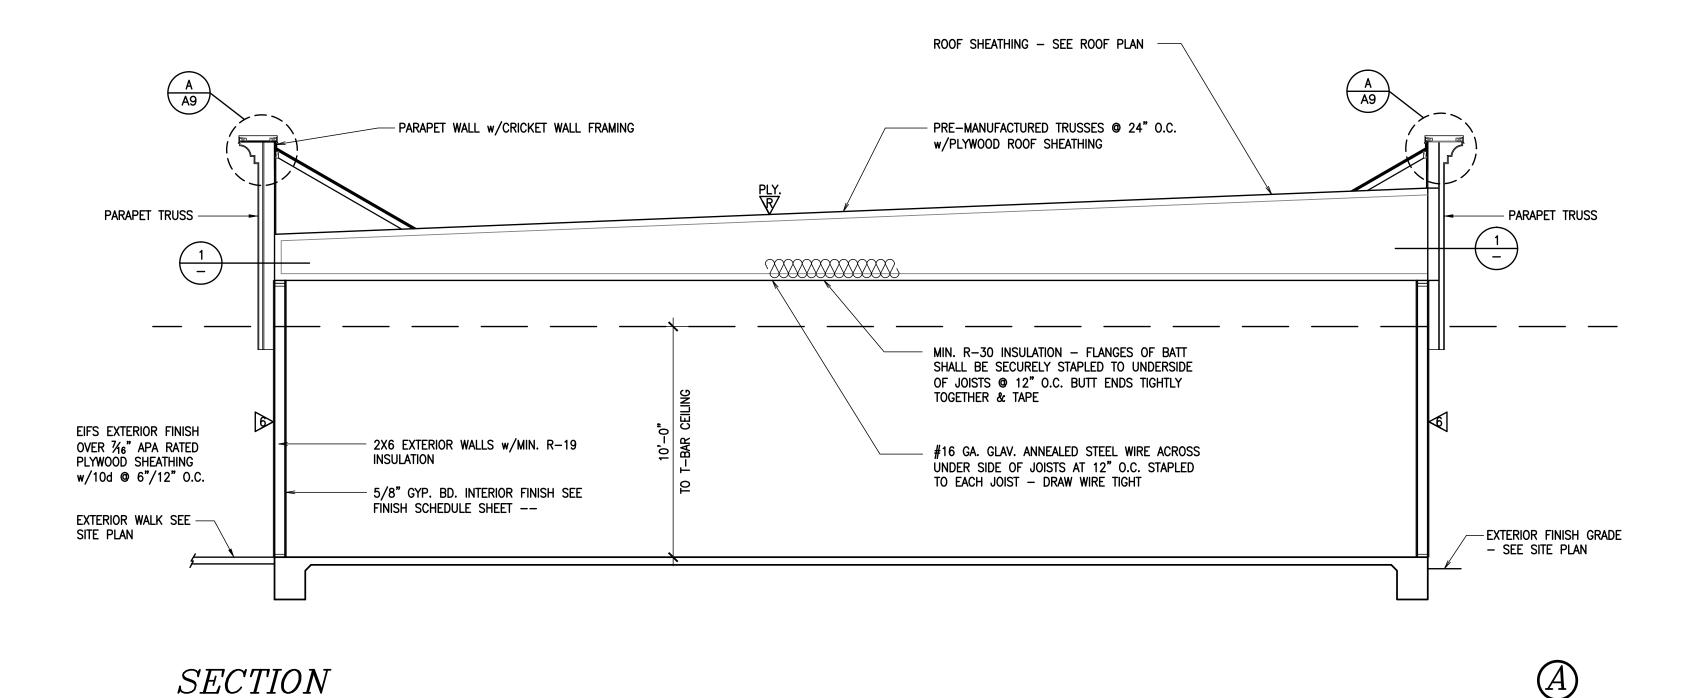

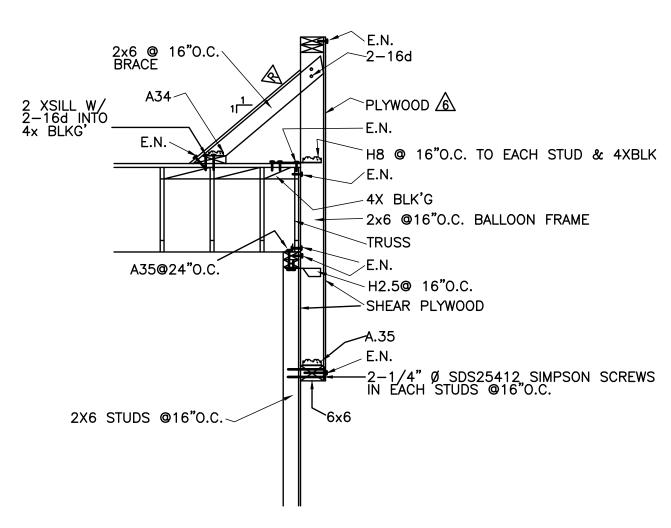

TRUSS PARALLEL TO POP OUT

JOB SHEET NO.

STOR

ROOF PLAN - ROOF FRAMING PLAN

PROPOSED CONVENIENCE


WILLIES MARKET


690 N ELMWOOD AVE

/-**Architect** (661) 324-5252 FAX (661) 324-8439

CONTRACTOR SHALL VERIFY ALL DIMENSIONS PRIOR TO CONSTRUCTION. DO NOT SCALE PLANS. WILLIAMSON CHAVEZ DESIGN ASSUMES NO RESPONSIBILITY FOR ITEMS NOT A PART OF THE APPROVED AND SIGNED PLANS. CONTRACTOR SHALL NOTIFY WILLIAMSON CHAVEZ DESIGN IMMEDIATELY OF ANY DISCREPANCIES OR ERRORS DETECTED IN THE APPROVED SET OF PLANS.

SCALE: 1/4" = 1'-0"

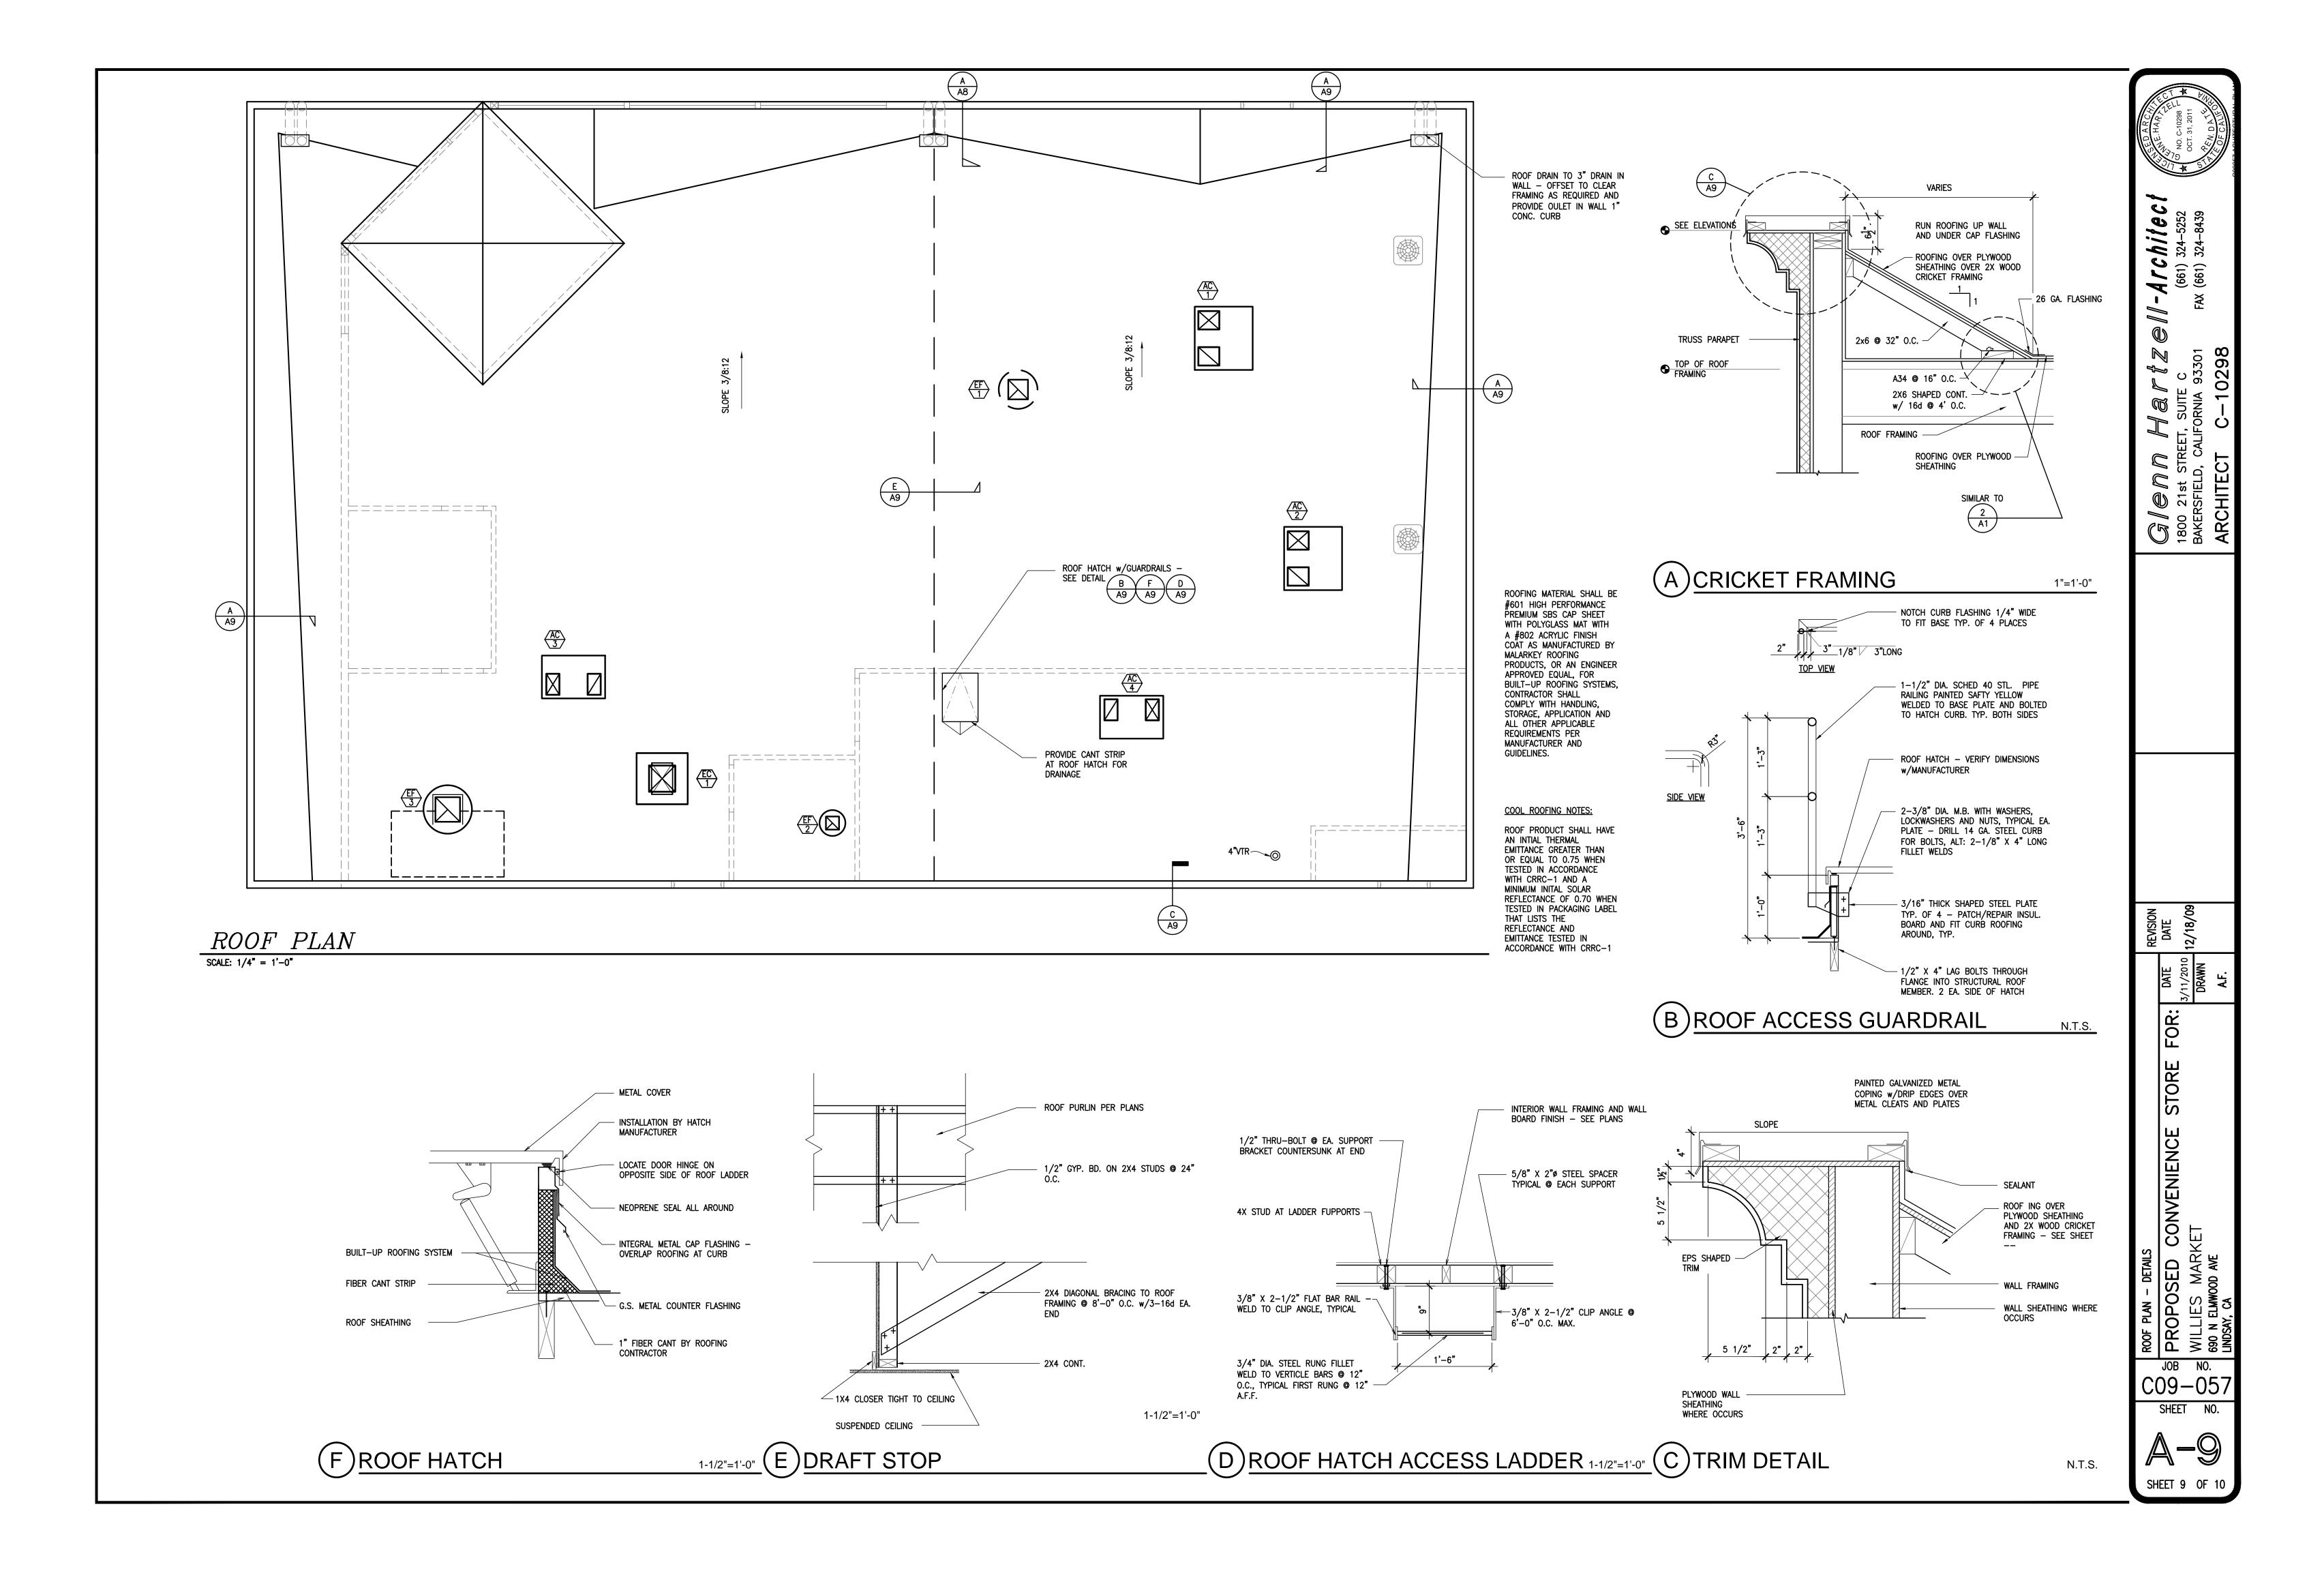

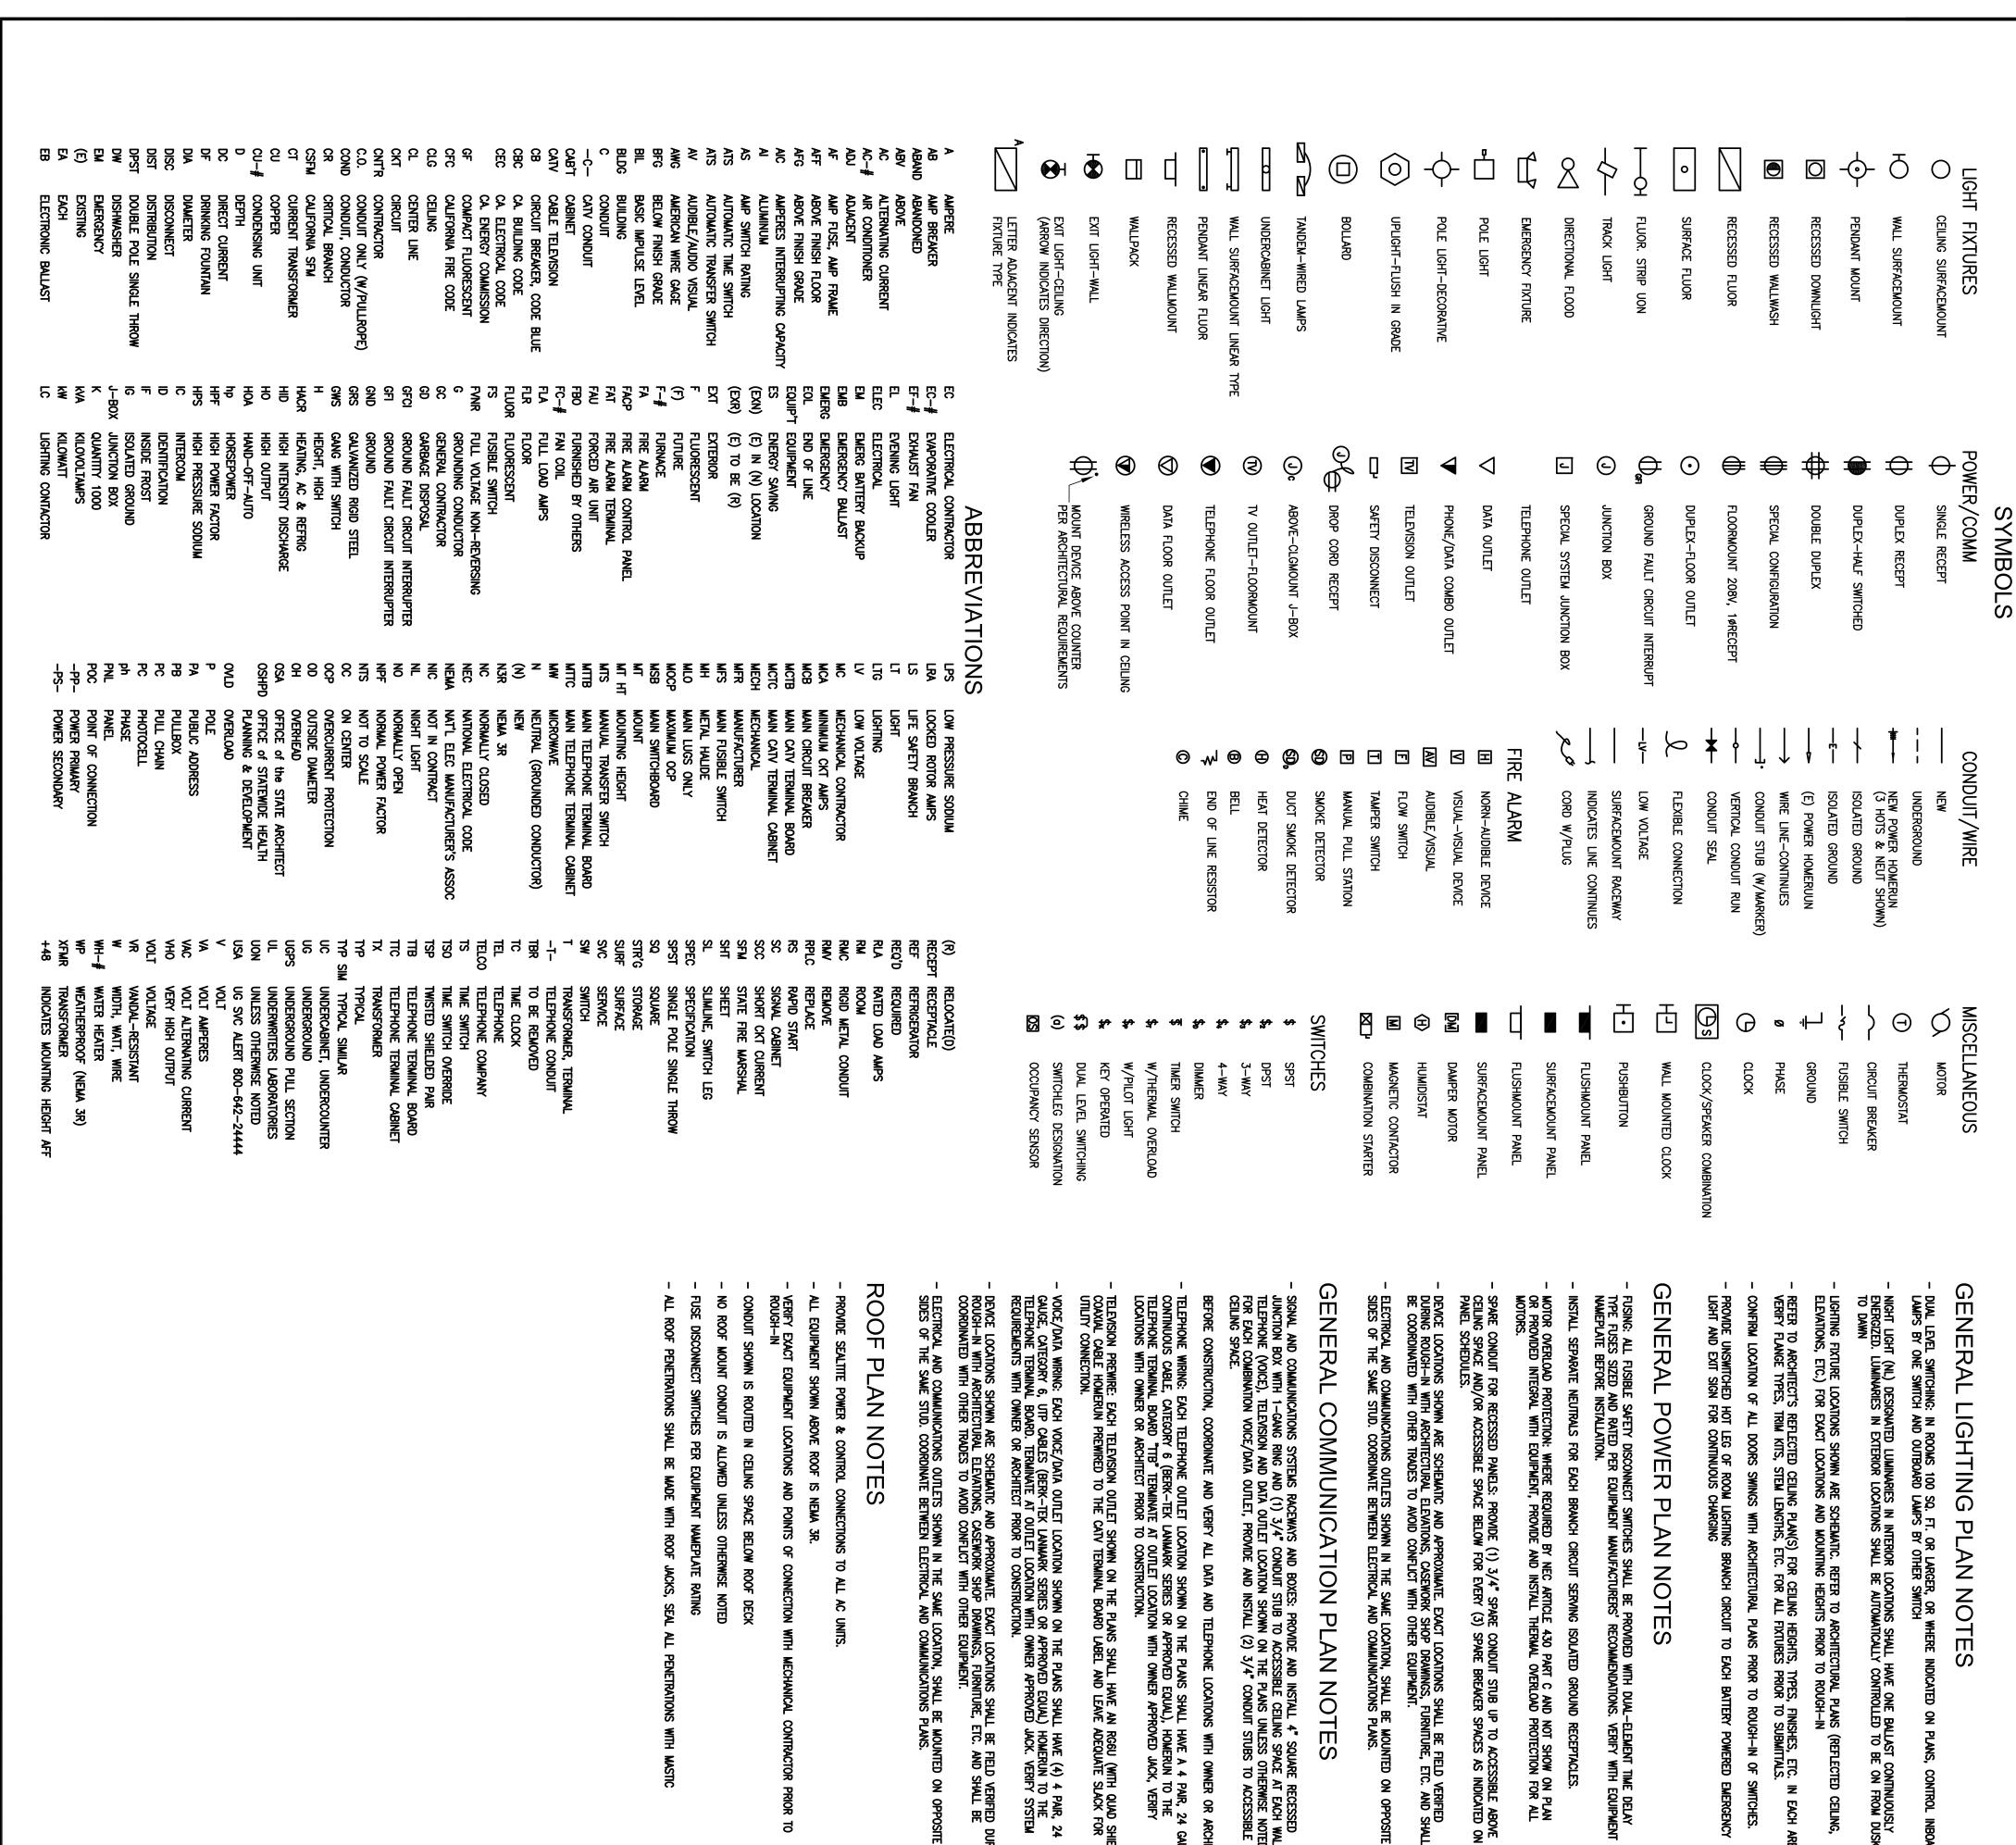

- NIGHT LIGHT (NL) DESIGNATED LUMINARIES IN INTERIOR LOCATIONS SHALL HAVE ONE BALLAST CONTINUOUSLY ENERGIZED. LUMINARIES IN EXTERIOR LOCATIONS SHALL BE AUTOMATICALLY CONTROLLED TO BE ON FROM DUSK TO DAWN
- CONFIRM LOCATION OF ALL DOORS SWINGS WITH ARCHITECTURAL PLANS PRIOR TO ROUGH—IN OF SWITCHES.

  PROVIDE UNSWITCHED HOT LEG OF ROOM LIGHTING BRANCH CIRCUIT TO EACH BATTERY POWERED EMERGENCY LIGHT AND EXIT SIGN FOR CONTINUOUS CHARGING REFER TO ARCHITECT'S REFLECTED CEILING PLAN(S) FOR CEILING HEIGHTS, TYPES, FINISHES, ETC. IN EACH AREA. VERIFY FLANGE TYPES, TRIM KITS, STEM LENGTHS, ETC. FOR ALL FIXTURES PRIOR TO SUBMITTALS.

### GENERAL POWER PLAN NOTES

- FUSING: ALL FUSIBLE SAFETY DISCONNECT SWITCHES SHALL BE PROVIDED WITH DUAL—ELEMENT TIME DELAY TYPE FUSES SIZED AND RATED PER EQUIPMENT MANUFACTURERS' RECOMMENDATIONS. VERIFY WITH EQUIPMENT NAMEPLATE BEFORE INSTALLATION.
- MOTOR OVERLOAD PROTECTION: WHERE REQUIRED BY NEC ARTICLE 430 PART C AND NOT SHOW ON PLAN OR PROVIDED INTEGRAL WITH EQUIPMENT, PROVIDE AND INSTALL THERMAL OVERLOAD PROTECTION FOR ALL MOTORS. INSTALL SEPARATE NEUTRALS FOR EACH BRANCH CIRCUIT SERVING ISOLATED GROUND RECEPTACLES.
- SPARE CONDUIT FOR RECESSED PANELS: PROVIDE (1) 3/4" SPARE CONDUIT STUB UP TO ACCESSIBLE ABOVE CEILING SPACE AND/OR ACCESSIBLE SPACE BELOW FOR EVERY (3) SPARE BREAKER SPACES AS INDICATED ON PANEL SCHEDULES. DEVICE LOCATIONS SHOWN ARE SCHEMATIC AND APPROXIMATE. EXACT LOCATIONS SHALL BE FIELD VERIFIED DURING ROUGH—IN WITH ARCHITECTURAL ELEVATIONS, CASEWORK SHOP DRAWINGS, FURNITURE, ETC. AND SHALL BE COORDINATED WITH OTHER TRADES TO AVOID CONFLICT WITH OTHER EQUIPMENT.

# GENERAL COMMUNICATION PLAN NOTES

- SIGNAL AND COMMUNICATIONS SYSTEMS RACEWAYS AND BOXES: PROVIDE AND INSTALL 4" SQUARE RECESSED JUNCTION BOX WITH 1—GANG RING AND (1) 3/4" CONDUIT STUB TO ACCESSIBLE CEILING SPACE AT EACH WALL TELEPHONE (VOICE), TELEVISION AND DATA OUTLET LOCATION SHOWN ON THE PLANS UNLESS OTHERWISE NOTED FOR EACH COMBINATION VOICE/DATA OUTLET, PROVIDE AND INSTALL (2) 3/4" CONDUIT STUBS TO ACCESSIBLE CEILING SPACE.
- TELEPHONE WIRING: EACH TELEPHONE OUTLET LOCATION SHOWN ON THE PLANS SHALL HAVE A 4 PAIR, 24 GAUGE CONTINUOUS CABLE, CATEGORY 6 (BERK—TEK LANMARK SERIES OR APPROVED EQUAL), HOMERUN TO THE TELEPHONE TERMINAL BOARD "TIB" TERMINATE AT OUTLET LOCATION WITH OWNER APPROVED JACK, VERIFY LOCATIONS WITH OWNER OR ARCHITECT PRIOR TO CONSTRUCTION. BEFORE CONSTRUCTION, COORDINATE AND VERIFY ALL DATA AND TELEPHONE LOCATIONS WITH OWNER OR ARCHITECT
- TELEVISION PREWIRE: EACH TELEVISION OUTLET SHOWN ON THE PLANS SHALL HAVE AN RG6U (WITH QUAD SHIELD) COAXIAL CABLE HOMERUN PREWIRED TO THE CATV TERMINAL BOARD LABEL AND LEAVE ADEQUATE SLACK FOR UTILITY CONNECTION.
- VOICE/DATA WIRING: EACH VOICE/DATA OUTLET LOCATION SHOWN ON THE PLANS SHALL HAVE (4) 4 PAIR, 24 GAUGE, CATEGORY 6, UTP CABLES (BERK-TEK LANMARK SERIES OR APPROVED EQUAL) HOMERUN TO THE TELEPHONE TERMINAL BOARD. TERMINATE AT OUTLET LOCATION WITH OWNER APPROVED JACK. VERIFY SYSTEM REQUIREMENTS WITH OWNER OR ARCHITECT PRIOR TO CONSTRUCTION.
- DEVICE LOCATIONS SHOWN ARE SCHEMATIC AND APPROXIMATE. EXACT LOCATIONS SHALL BE FIELD VERIFIED DURING ROUGH—IN WITH ARCHITECTURAL ELEVATIONS, CASEWORK SHOP DRAWINGS, FURNITURE, ETC. AND SHALL BE COORDINATED WITH OTHER TRADES TO AVOID CONFLICT WITH OTHER EQUIPMENT.
- ELECTRICAL AND COMMUNICATIONS OUTLETS SHOWN IN THE SAME LOCATION, SHALL BE MOUNTED ON OPPOSITE SIDES OF THE SAME STUD. COORDINATE BETWEEN ELECTRICAL AND COMMUNICATIONS PLANS.

- PROVIDE SEALTITE POWER & CONTROL CONNECTIONS TO ALL AC UNITS.
- VERIFY EXACT EQUIPMENT LOCATIONS AND POINTS OF CONNECTION WITH MECHANICAL CONTRACTOR PRIOR TO ROUGH—IN
- NO ROOF MOUNT CONDUIT IS ALLOWED UNLESS OTHERWISE NOTED
- ALL ROOF PENETRATIONS SHALL BE MADE WITH ROOF JACKS, SEAL

## GENERAL LIGHTING PLAN NOTES

- DUAL LEVEL SWITCHING: IN ROOMS 100 SQ. FT. OR LARGER, OR WHERE INDICATED ON PLANS, CONTROL INBOARD LAMPS BY ONE SWITCH AND OUTBOARD LAMPS BY OTHER SWITCH
- LIGHTING FIXTURE LOCATIONS SHOWN ARE SCHEMATIC. REFER TO ARCHITECTURAL PLANS (REFLECTED CEILING, ELEVATIONS, ETC.) FOR EXACT LOCATIONS AND MOUNTING HEIGHTS PRIOR TO ROUGH—IN

**GENERAL NOTES** 

CONFORM TO AND BE PERFORMED IN ACCORDANCE WITH CODES, STANDARDS AND ORDINANCES AS SET JURISDICTION AND THEIR LATEST ADOPTED EDITIONS (IN EFFECT AT TIME OF BUILDING PERMIT APPLICATION)


NO. C-10298

OCT. 31, 2011

- B. AMERICANS WITH DISABILITIES ACT A. CALIFORNIA CODE OF REGULATIONS TITLE 24; INCLUDES 2004 NATIONAL ELECTRICAL CODE, UNIFORM FIRE CODE, UNIFORM BUILDING CODE, ETC. WITH CALIFORNIA AND OTHER LOCAL AMENDMENTS AS APPLICABLE.
- FIRE RATED ASSEMBLIES SHALL MAINTAIN RATINGS AS SPECIFIED IN THE CALIFORNIA BUILDING CODE CHAPTER 7. CONTRACTOR SHALL PROVIDE AND INSTALL PHYSICAL ENCLOSURE AROUND FIXTURES, PANELS, ETC. AS REQUIRED. ALL ASSEMBLIES TO BE PENETRATED SHALL BE INSTALLED WITH APPLICABLE THROUGH—PENETRATION FIRESTOP SYSTEM AS DETERMINED BY UL CLASSIFICATION. BEFORE CONSTRUCTION, VERIFY AND COMPLY WITH REQUIREMENTS OF LOCAL AUTHORITY HAVING JURISDICTION. SAFETY: THE ELECTRICAL CONTRACTOR IS RESPONSIBLE TO MAINTAIN ALL EQUIPMENT IN A SAFE AND RESPONSIBLE MANNER. KEEP DEAD FRONT EQUIPMENT IN PLACE WHILE EQUIPMENT IS ENERGIZED. CONDUCT ALL CONSTRUCTION OPERATIONS IN A SAFE MANNER FOR EMPLOYEES AS WELL AS OTHER WORKPERSONS OR ANYONE VISITING THE JOB SITE. PROVIDE BARRIERS, FLAGS, TAPE, ETC. AS REQUIRED FOR SAFETY. THE CONTRACTOR SHALL HOLD ALL PARTIES HARMLESS OF NEGLIGENT SAFETY PRACTICES, WHICH MAY CAUSE INJURY TO OTHERS ON OR NEAR THE JOB SITE.
- MOUNTING HEIGHTS IN INCHES TO CENTERLINE ABOVE FINISH FLOOR SHALL BE AS FOLLOWS UNLESS OTHERWISE NOTED: +18" AFF: RECEPTACLES, TELEPHONE, TV & DATA OUTLETS
  +48" AFF: LIGHT SWITCHES
  +48" AFF: FIRE ALARM MANUAL PULL STATIONS, T-STATS
  THE LOWER OF +80" AFF OR 6" BELOW CEILING: FIRE ALARM
  VISUALS
- LABEL PANELS, CABINETS, BACKBOARDS, MAIN DEVICES, SAFETY SWITCHES, CONTACTORS AND OTHER SPECIFICALLY DESIGNATED EQUIPMENT SHOWN ON PLANS. USE ENGRAVED LAMINATED PLASTIC NAMEPLATES ATTACHED BY SCREWS OR RIVETS. FOR FEEDERS, NEATLY AND INDELIBLY LABEL CONDUIT DESTINATIONS ON BOTH VISIBLE ENDS OF CONDUIT RUNS WHERE CONDUITS TERMINATE AT DESIGNATED ENCLOSURES, STRUCTURES OR EQUIPMENT (INCLUDING PULL AND SPLICE BOXES) BEFORE ROUGH—IN, VERIFY ALL MOUNTING HEIGHTS AND EXACT LOCATIONS FOR ALL EQUIPMENT ELECTRICAL CONNECTIONS, STUB—UPS, RECEPTACLES, OUTLETS, ETC. WITH ARCHITECT OR OWNER. PLACE DEVICES LOCATED ABOVE COUNTERS, SHELVING, ETC. AND BATHROOMS SO AS NOT TO CONFLICT WITH EDGES OF WAINSCOTING, COUNTER SPLASH, SHELVING, ETC. ARCHITECTURAL SHEETS SHALL GOVERN.
- EQUIPMENT ANCHORAGE: BRACE OR A A. FIXED EQUIPMENT ON GRADE 30% OF OPERATING WEIGHT.
  B. FIXED EQUIPMENT ON STRUCTURE 45% OF OPERATING WEIGHT.
  C. EMERGENCY POWER EQUIPMENT ON GRADE 40% OF OPERATING WEIGHT.
  D. EMERGENCY POWER EQUIPMENT ON STRUCTURE 60% OF OPERATING WEIGHT. NICHOR ALL ELECTRICAL EQUIPMENT TO RESIST A HORIZONTAL FORCE ACTING IN ANY DIRECTION. USE THE
- EXCEPTIONS: FOR FLEXIBLY MOUNTED E FORCE. SEE STRUCTURAL PLANS FOR A INSTALLATION SHALL BE SUBJECT TO THE JURISDICTION. SHOULD SAID APPROVAL INSTALLATION AS REQUIRED TO GAIN AP EQUIPMENT USE 4X THE ABOVE VALUES; FOR SIMULTANEOUS VERTICAL FORCE, USE ANCHORAGE DETAILS AND WHERE ANCHORAGE DETAILS ARE NOT SHOWN ON THE DRY THE APPROVAL OF THE STRUCTURAL ENGINEER AND THE FIELD REPRESENTATIVE OF 1 L BE WITHHELD, ELECTRICAL CONTRACTOR SHALL, AT NO EXTRA COST TO THE OWNER APPROVAL
- MECHANICAL SYSTEMS . NOT USED MECHANICAL UNIT CONDUITS: TO PREVENT DAMAGE DUE TO VIBRATION, BOTH POWER AND CONTROL WIRING CONDUITS FEEDING EXTERIOR MECHANICAL UNITS SHALL BE PROVIDED AND INSTALLED BY ELECTRICAL CONTRACTOR WITH LIQUID TIGHT FLEXIBLE TYPE AT FINAL CONNECTION TO UNIT AND BETWEEN ROOF JACK AND DISCONNECT SWITCH WHERE DISCONNECT IS MOUNTED ON UNIT.
- 3. T-STAT J-BOXES: PROVIDE AND INSTALL 4" SQUARE JUNCTION BOX WITH 1-GANG RING AND 1/2" CONDUIT TO ACCESSIBLE CEILING SPACE ABOVE AT EACH THERMOSTAT LOCATION MECHANICAL EQUIPMENT CONTROLS: 120 VOLT) TO AND FROM ALL MECHA NOTED. 4. EXHAUST FANS SHALL BE PROVIDED PULL ROPES: ANY RACEWAY WITHOUT CABLE OR WIRE SHALL BE INSTALLED WITH MINIMUM 200 POUND TEST PULL LINE AND LARGER IF REQUIRED BY SERVING UTILITY COMPANY. ANY NEW OR EXISTING COMMUNICATION OR SIGNAL RACEWAY ROUTED BETWEEN BUILDINGS, SIGNAL CABINETS, AND/OR SIGNAL CLOSETS WITH FUTURE CAPACITY SHALL BE INSTALLED WITH MINIMUM 200 POUND TEST PULL LINE AS WELL AS THE CALLED FOR CABLE MECHANICAL CONTRACTOR SHALL BE RESPONSIBLE FOR ALL LOW VOLTAGE WIRE AND CONNECTIONS (BELOW ANICAL CONTROL DEVICES. ALL LOW VOLTAGE CONTROL WIRE SHALL BE IN CONDUIT, UNLESS OTHERWISE & INSTALLED BY MECHANICAL CONTRACTOR WITH WIRING CONNECTIONS MADE BY ELECTRICAL CONTRACTOR
- EXISTING BUILDING 2. DUCT SMOKE DETECTORS SHALL BE PROVIDED BY ELECTRICAL CONTRACTOR AND INSTALLED BY MECHANICAL CONTRACTOR. DETECTOR POWER AND SUPERVISORY WIRING AND CONNECTIONS SHALL BE MADE BY MECHANICAL CONTRACTOR. MECHANICAL UNIT CONTROL (SHUTDOWN UPON DETECTOR ALARM) WIRING AND CONNECTIONS SHALL BE MADE BY MECHANICAL CONTRACTOR I. PROVIDE ALL WORK AND MATERIAL REQUIRED TO INSTALL DELAY EXIT PANIC HARDWARE IN COMPLIANCE WITH CBC 1003.3.1.10 FIRE ALARM SYSTEM
- EXISTING CONDITIONS: INFORMATION SHOWN FOR EXISTING CONDITIONS WAS PRIMARILY GAINED FROM "AS BUILT" DRAWINGS AND/OR LIMITED FIELD INVESTIGATION. BEFORE BID, VISIT SITE TO VERIFY EXISTING CONDITIONS AND MAKE ALLOWANCE FOR VARIATIONS FROM THAT SHOWN ANY DEMOLITION WORK SHOWN WAS PREPARED FOR THE CONVENIENCE OF THE CONTRACTOR. THE ENGINEER DOES NOT REPRESENT THAT ALL ITEMS WHICH MAY REQUIRE DEMOLITION HAVE BEEN SHOWN. IT SHALL BE THE RESPONSIBILITY OF THE CONTRACTOR TO CAREFULLY EXAMINE THE SITE AND THE CONTRACT DOCUMENTS AND TO PERFORM ALL DEMOLITION AND RECONSTRUCTION WHICH MAY BE REQUIRED FOR THE PROPER EXECUTION AND COMPLETION OF THE WORK
- 5. WHERE EXISTING BUILDING CONSTRUCTION, MECHANICAL UNITS AND OTHER EQUIPMENT IS SHOWN TO BE REMOVED, DISCONNECT AND REMOVE ALL ASSOCIATED ELECTRICAL INSTALLATION 4. EXISTING COMMUNICATIONS, DATA AND SHALL BE PERFORMED BY THE ELECTR LOCATION EXISTING CONDUCTORS: INTERCEPT, EXTEND, REROUTE, REPULL CONDUCTORS, SPLICE AND OTHERWISE MODIFY EXISTING CONDUCTORS OF ALL SYSTEMS AS REQUIRED TO MAINTAIN AND/OR ESTABLISH PROPER FUNCTION AND SATISFY DESIGN INTENT. REMOVE ABONDONED CONDUCTORS D CATV AND OTHER LOW VOLTAGE TYPE IRICAL CONTRACTOR. MODIFY EXISTING : E SYSTEM OUTLET LOCATIONS SHOWN ON THE PLAN TO BE RELOCATED SYSTEM AS REQUIRED FOR FULL FUNCTION (SAME AS EXISTING) IN NEW


CLOSELY COORDINATE OUTAGE AND FACILITY DISRUPTION TIME WITH ARCHITECT CIRCUIT SHUTDOWN OR DISRUPTION OF FACILITY PERSONNEL FUNCTIONING


SHEET

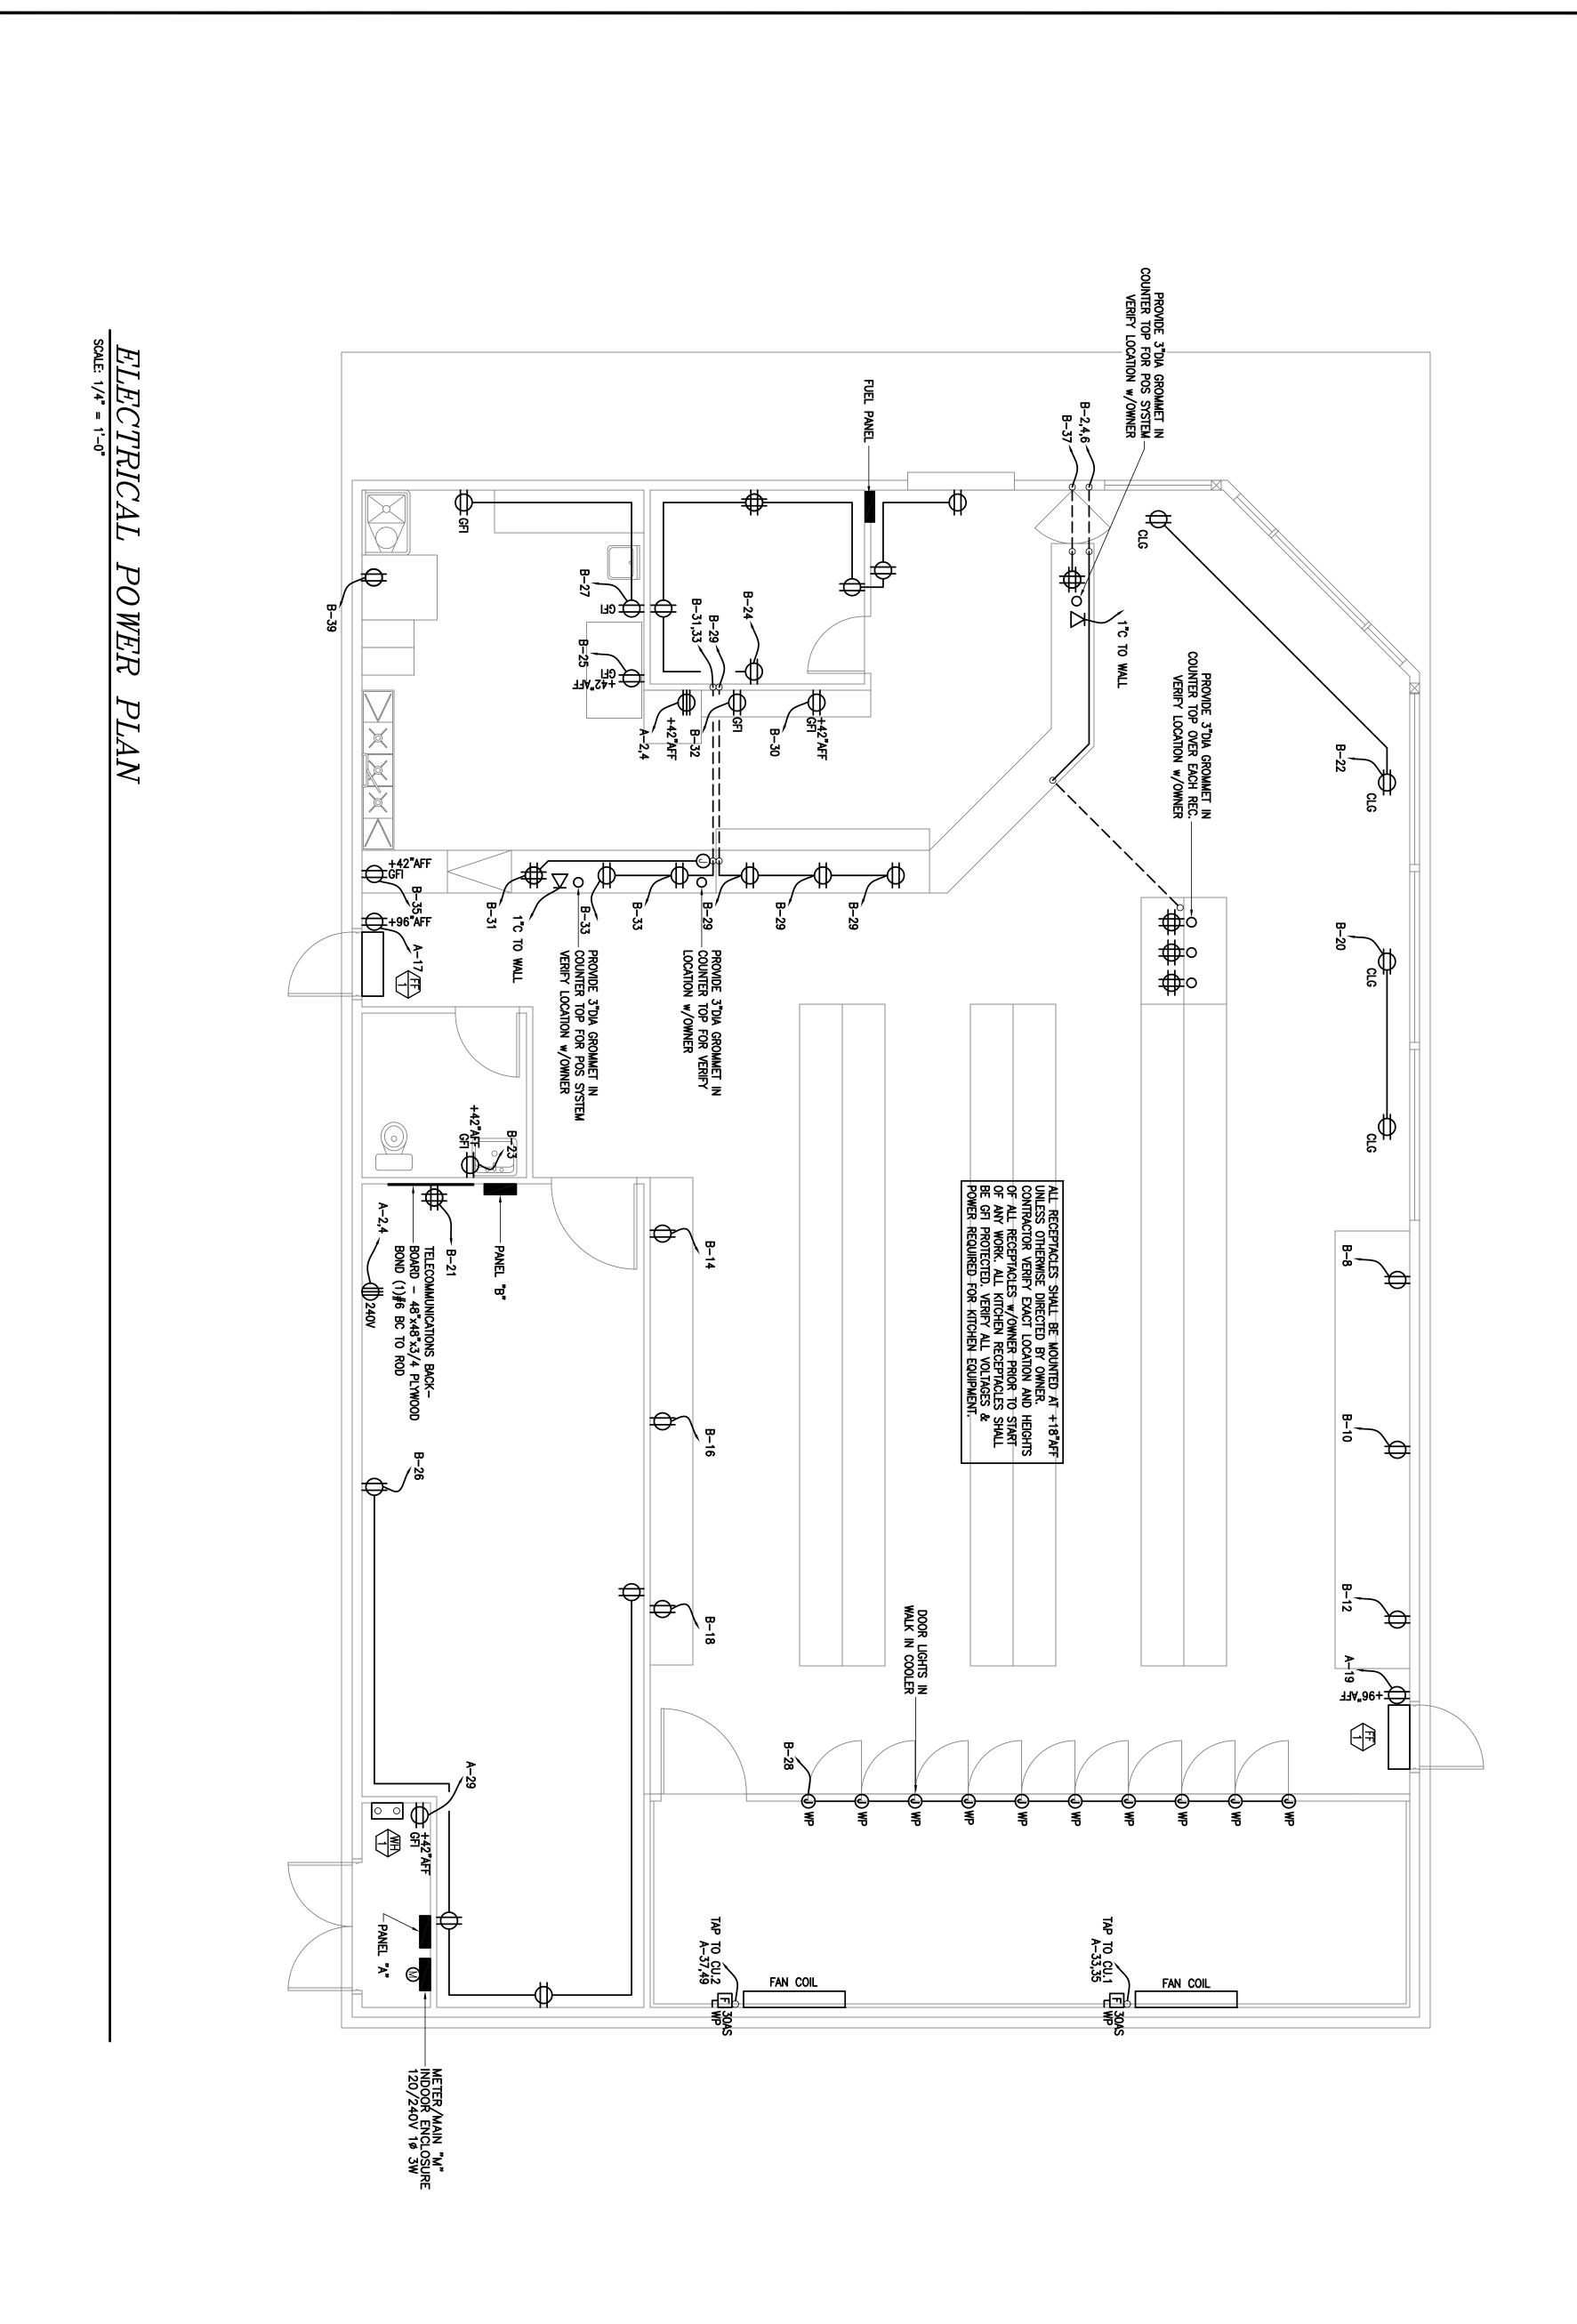

SHEET 2	] SHEET	<u> </u>		DATE 12/22/2009	REVISION DATE 12/18/09
OF 5	<b>)</b> §	NO.	WILLIES MARKET 690 N ELMWOOD AVE LINDSAY, CA	DRAWN A.F.	127 107 00




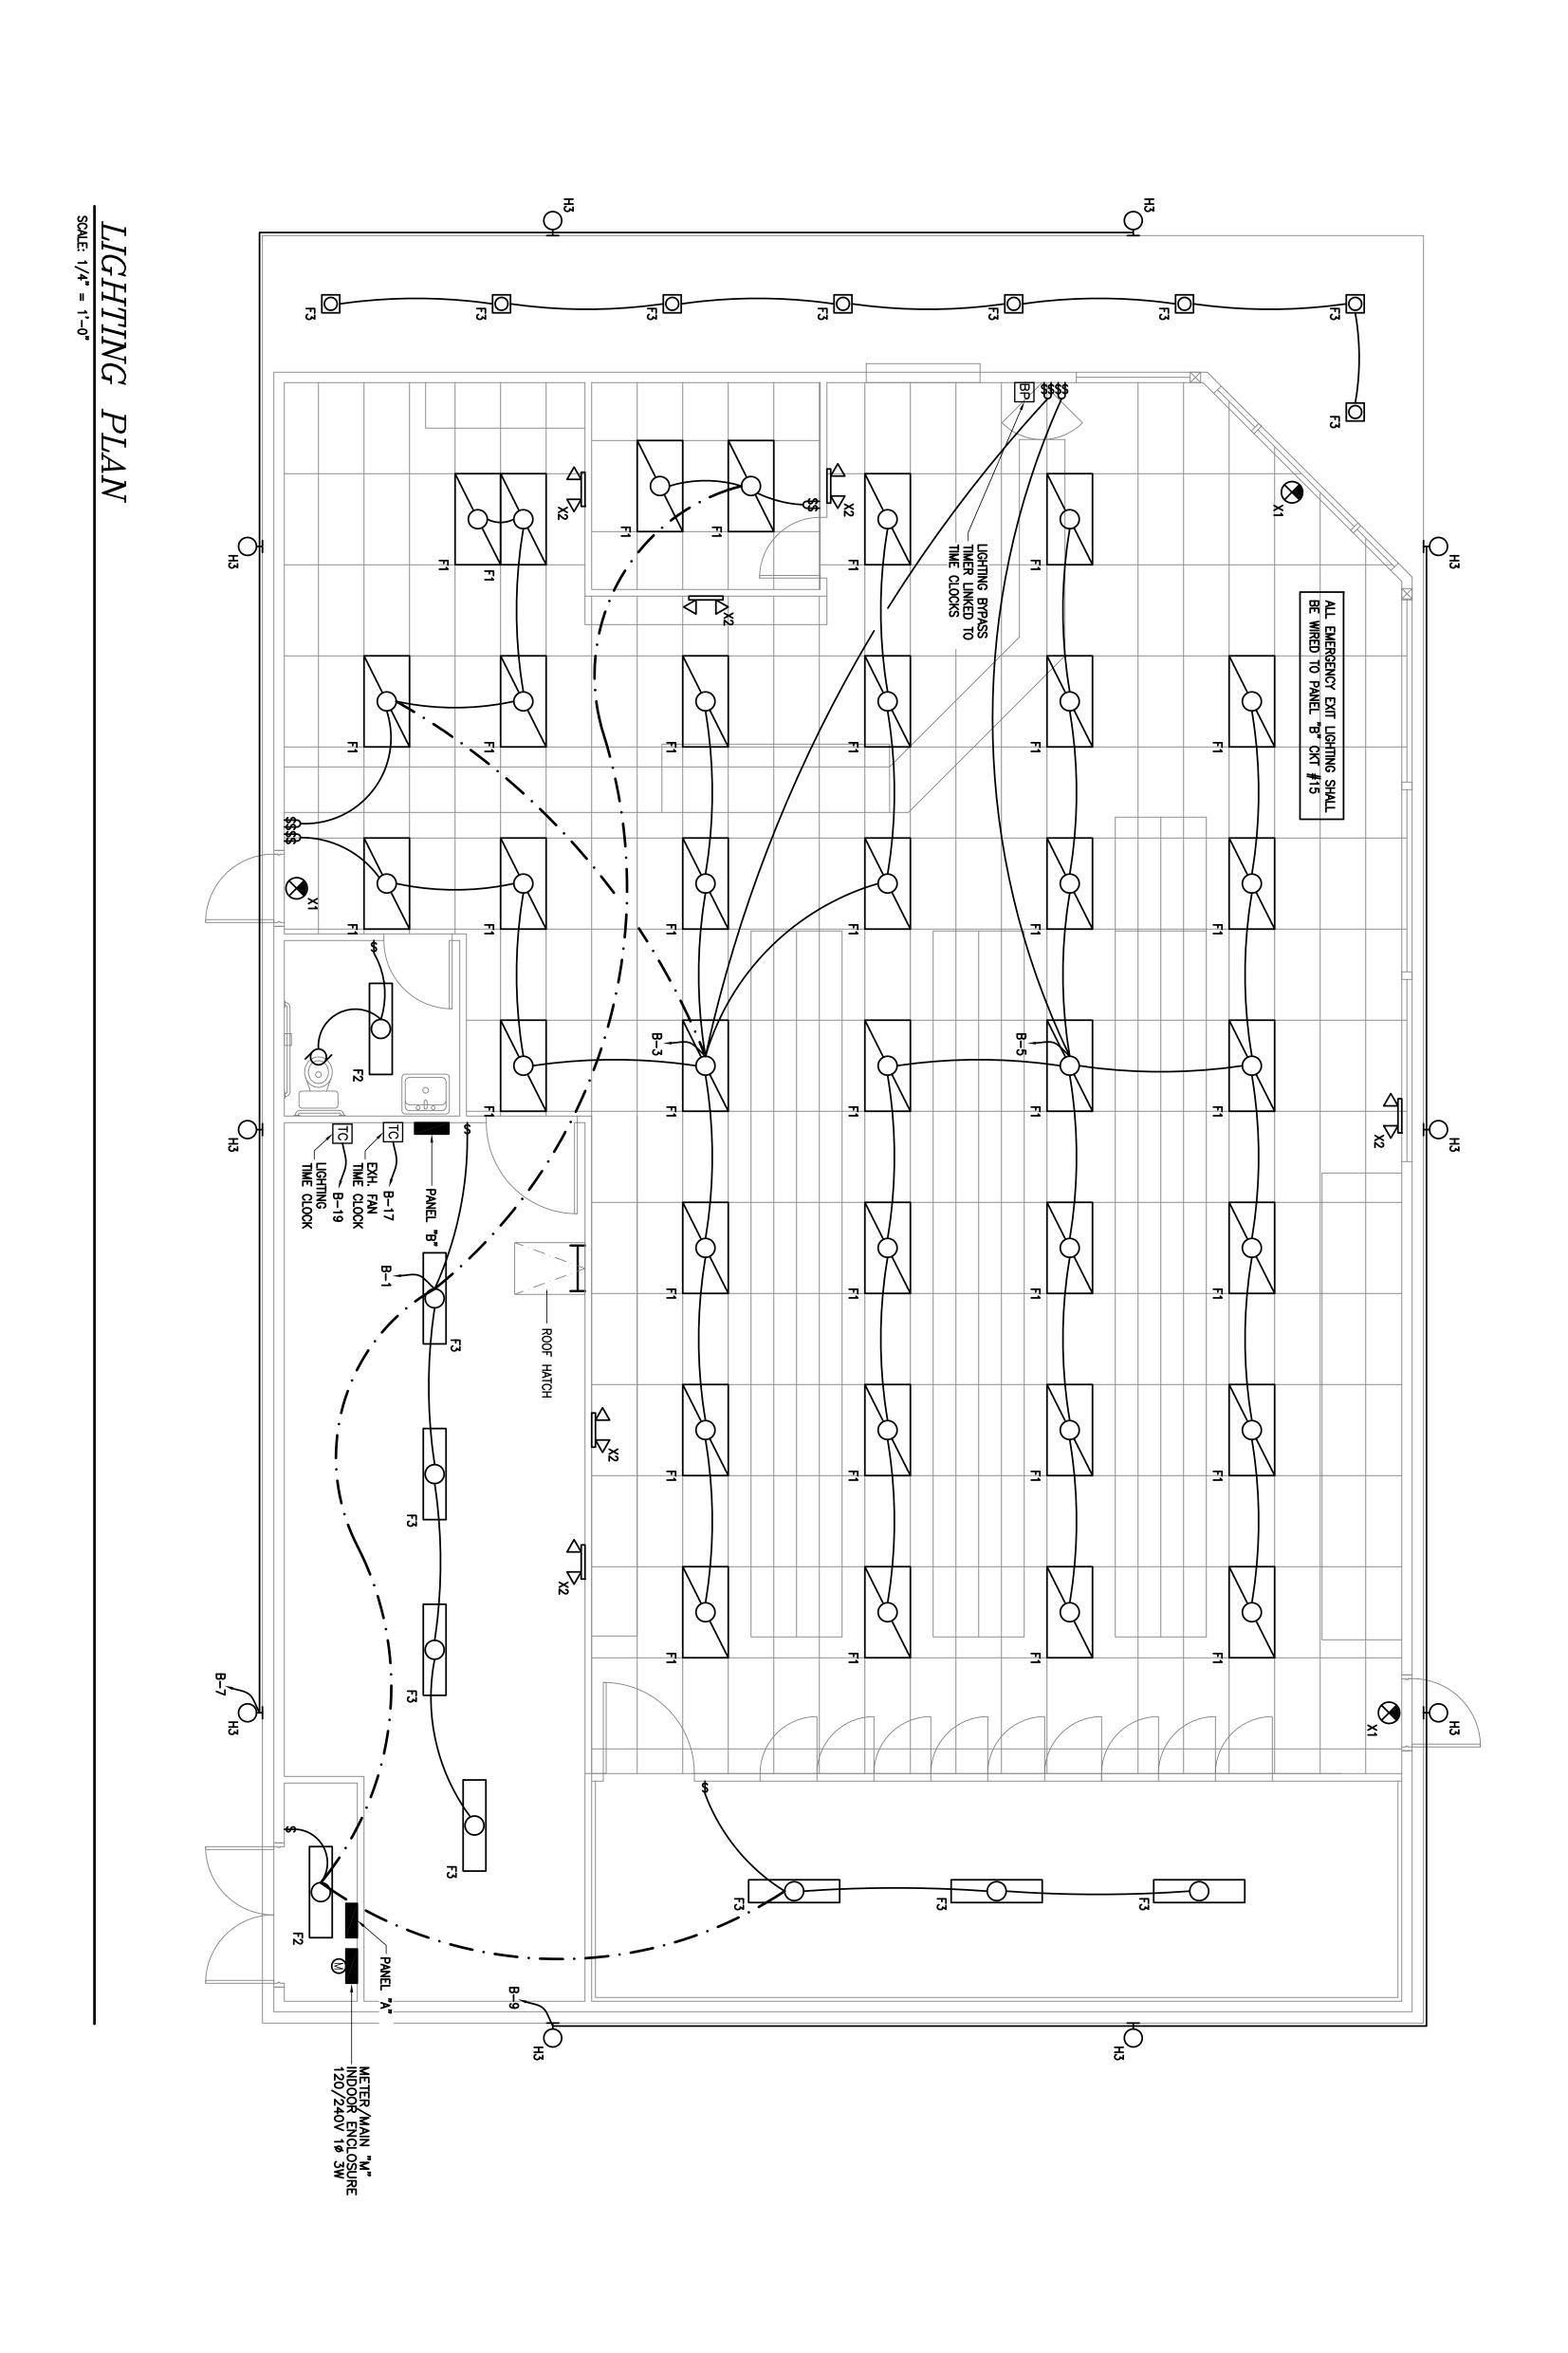

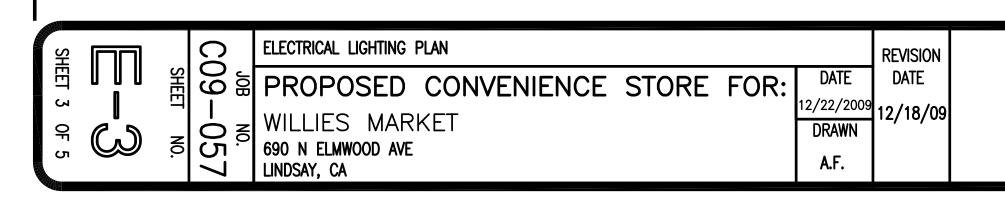




ELECTRICAL POWER ROOF PLAN

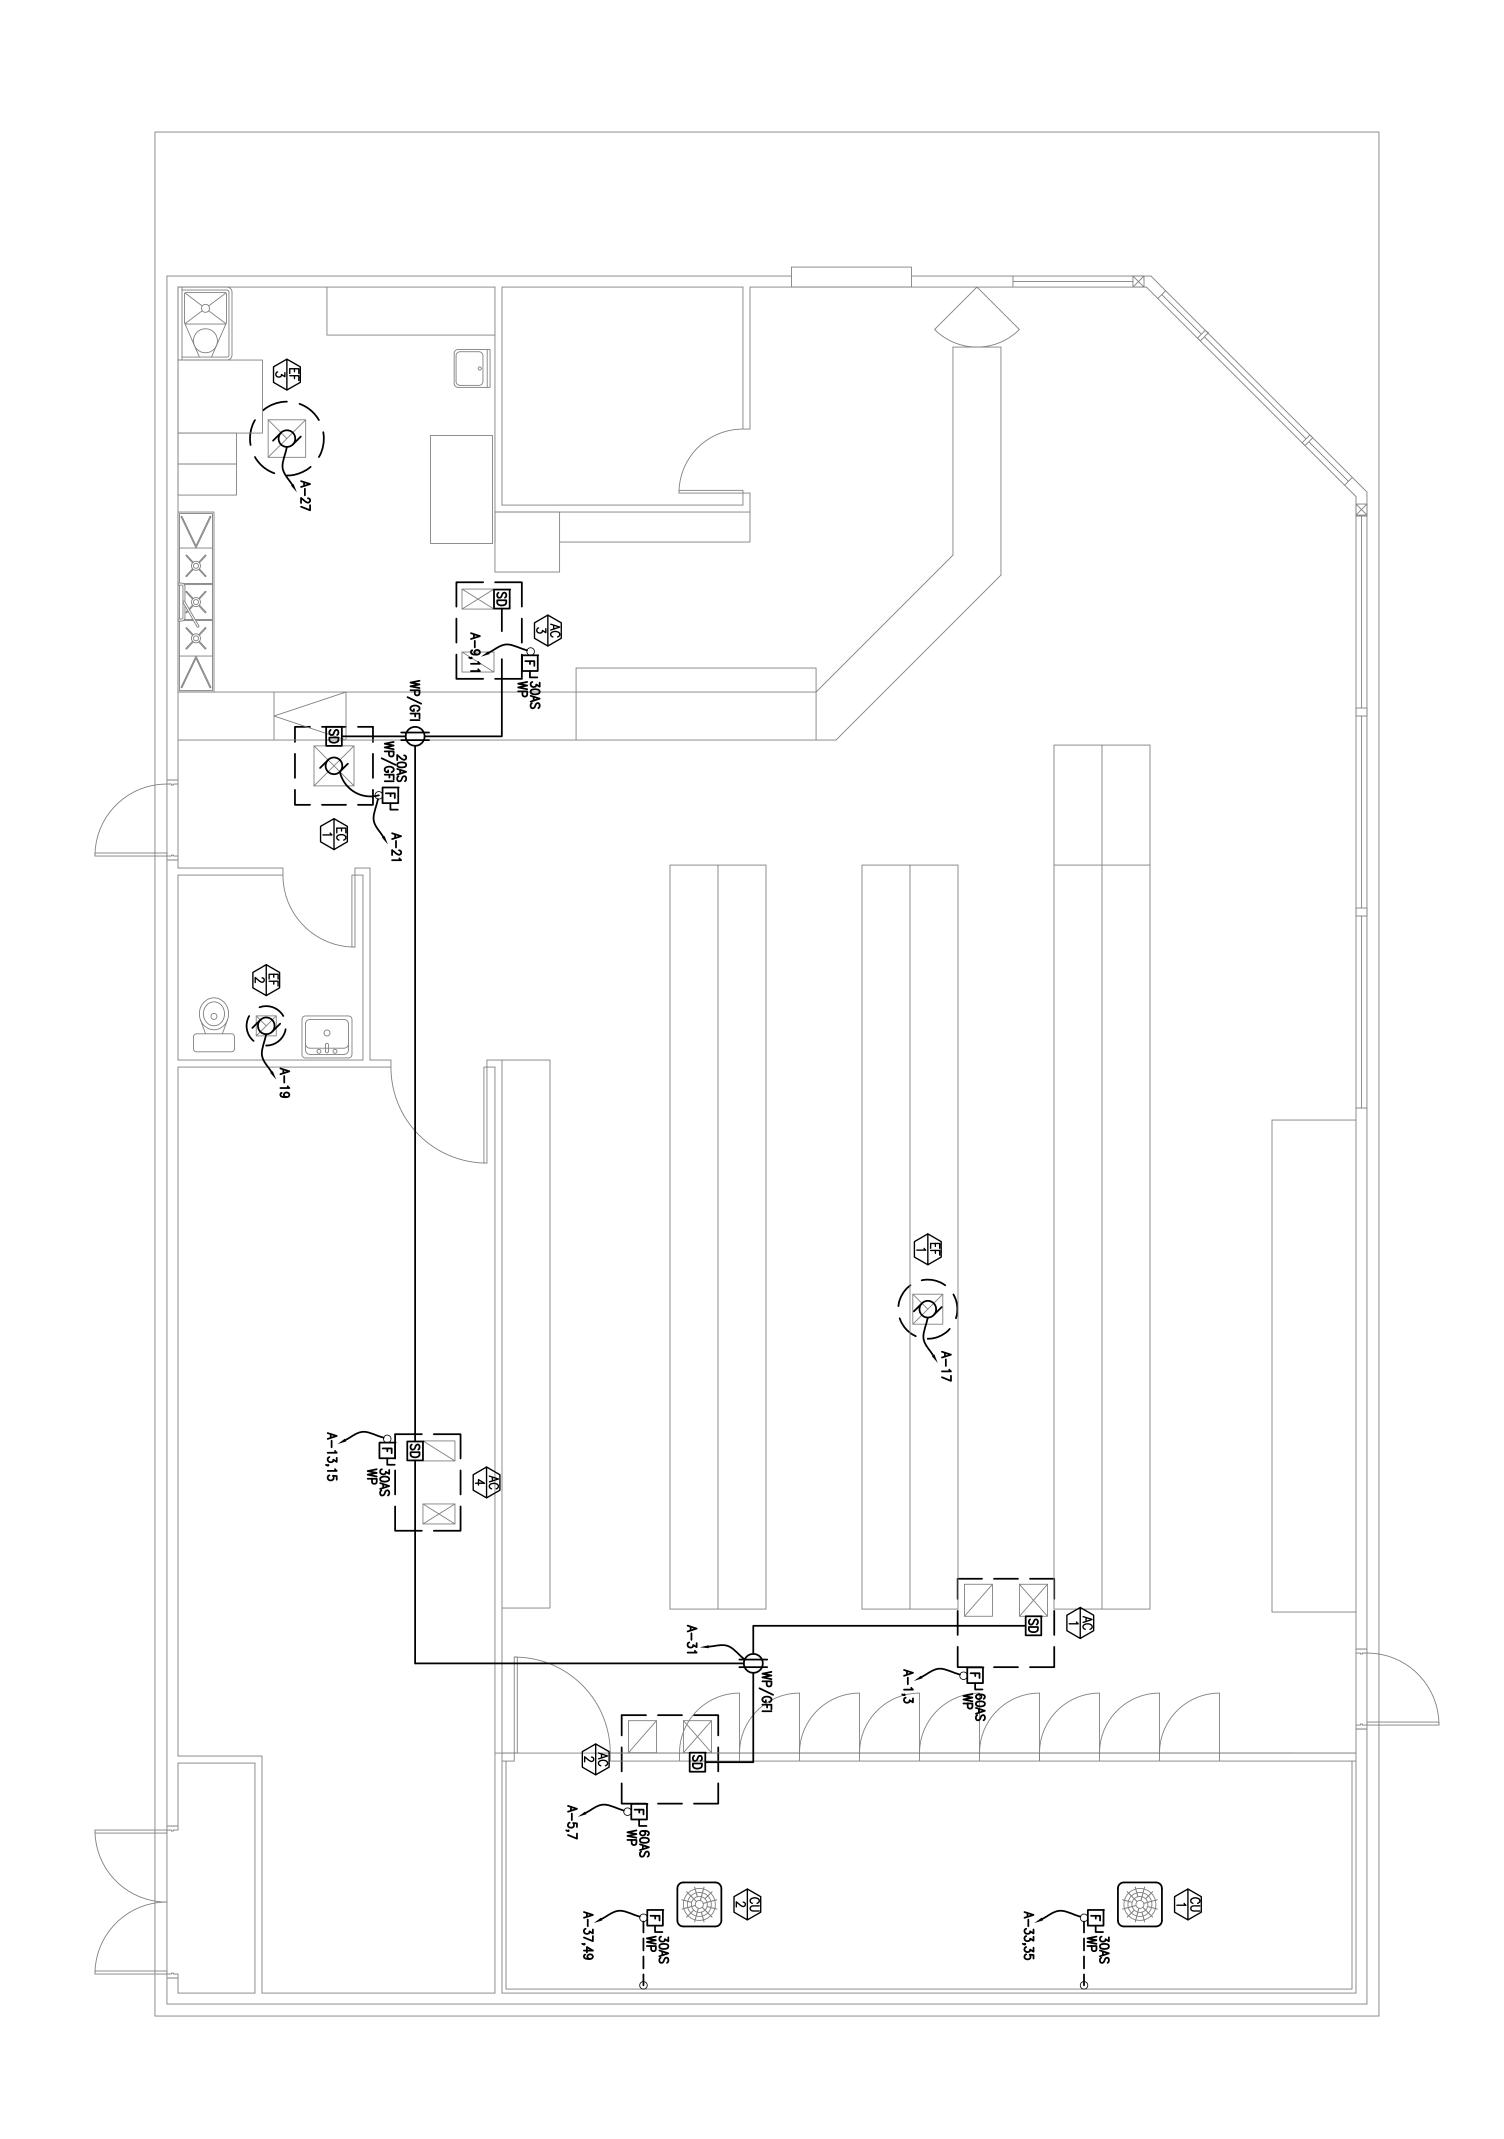

SHEET 4 OF 5	SHEET NO.	C09-057	ELECTRICAL POWER ROOF PLAN  PROPOSED CONVENIENCE STORE FOR:  WILLIES MARKET  690 N ELMWOOD AVE LINDSAY, CA  DATE  12/22/20  DRAWN  A.F.	REVISION DATE 9 12/18/09
--------------	-----------	---------	---	-----------------------------------



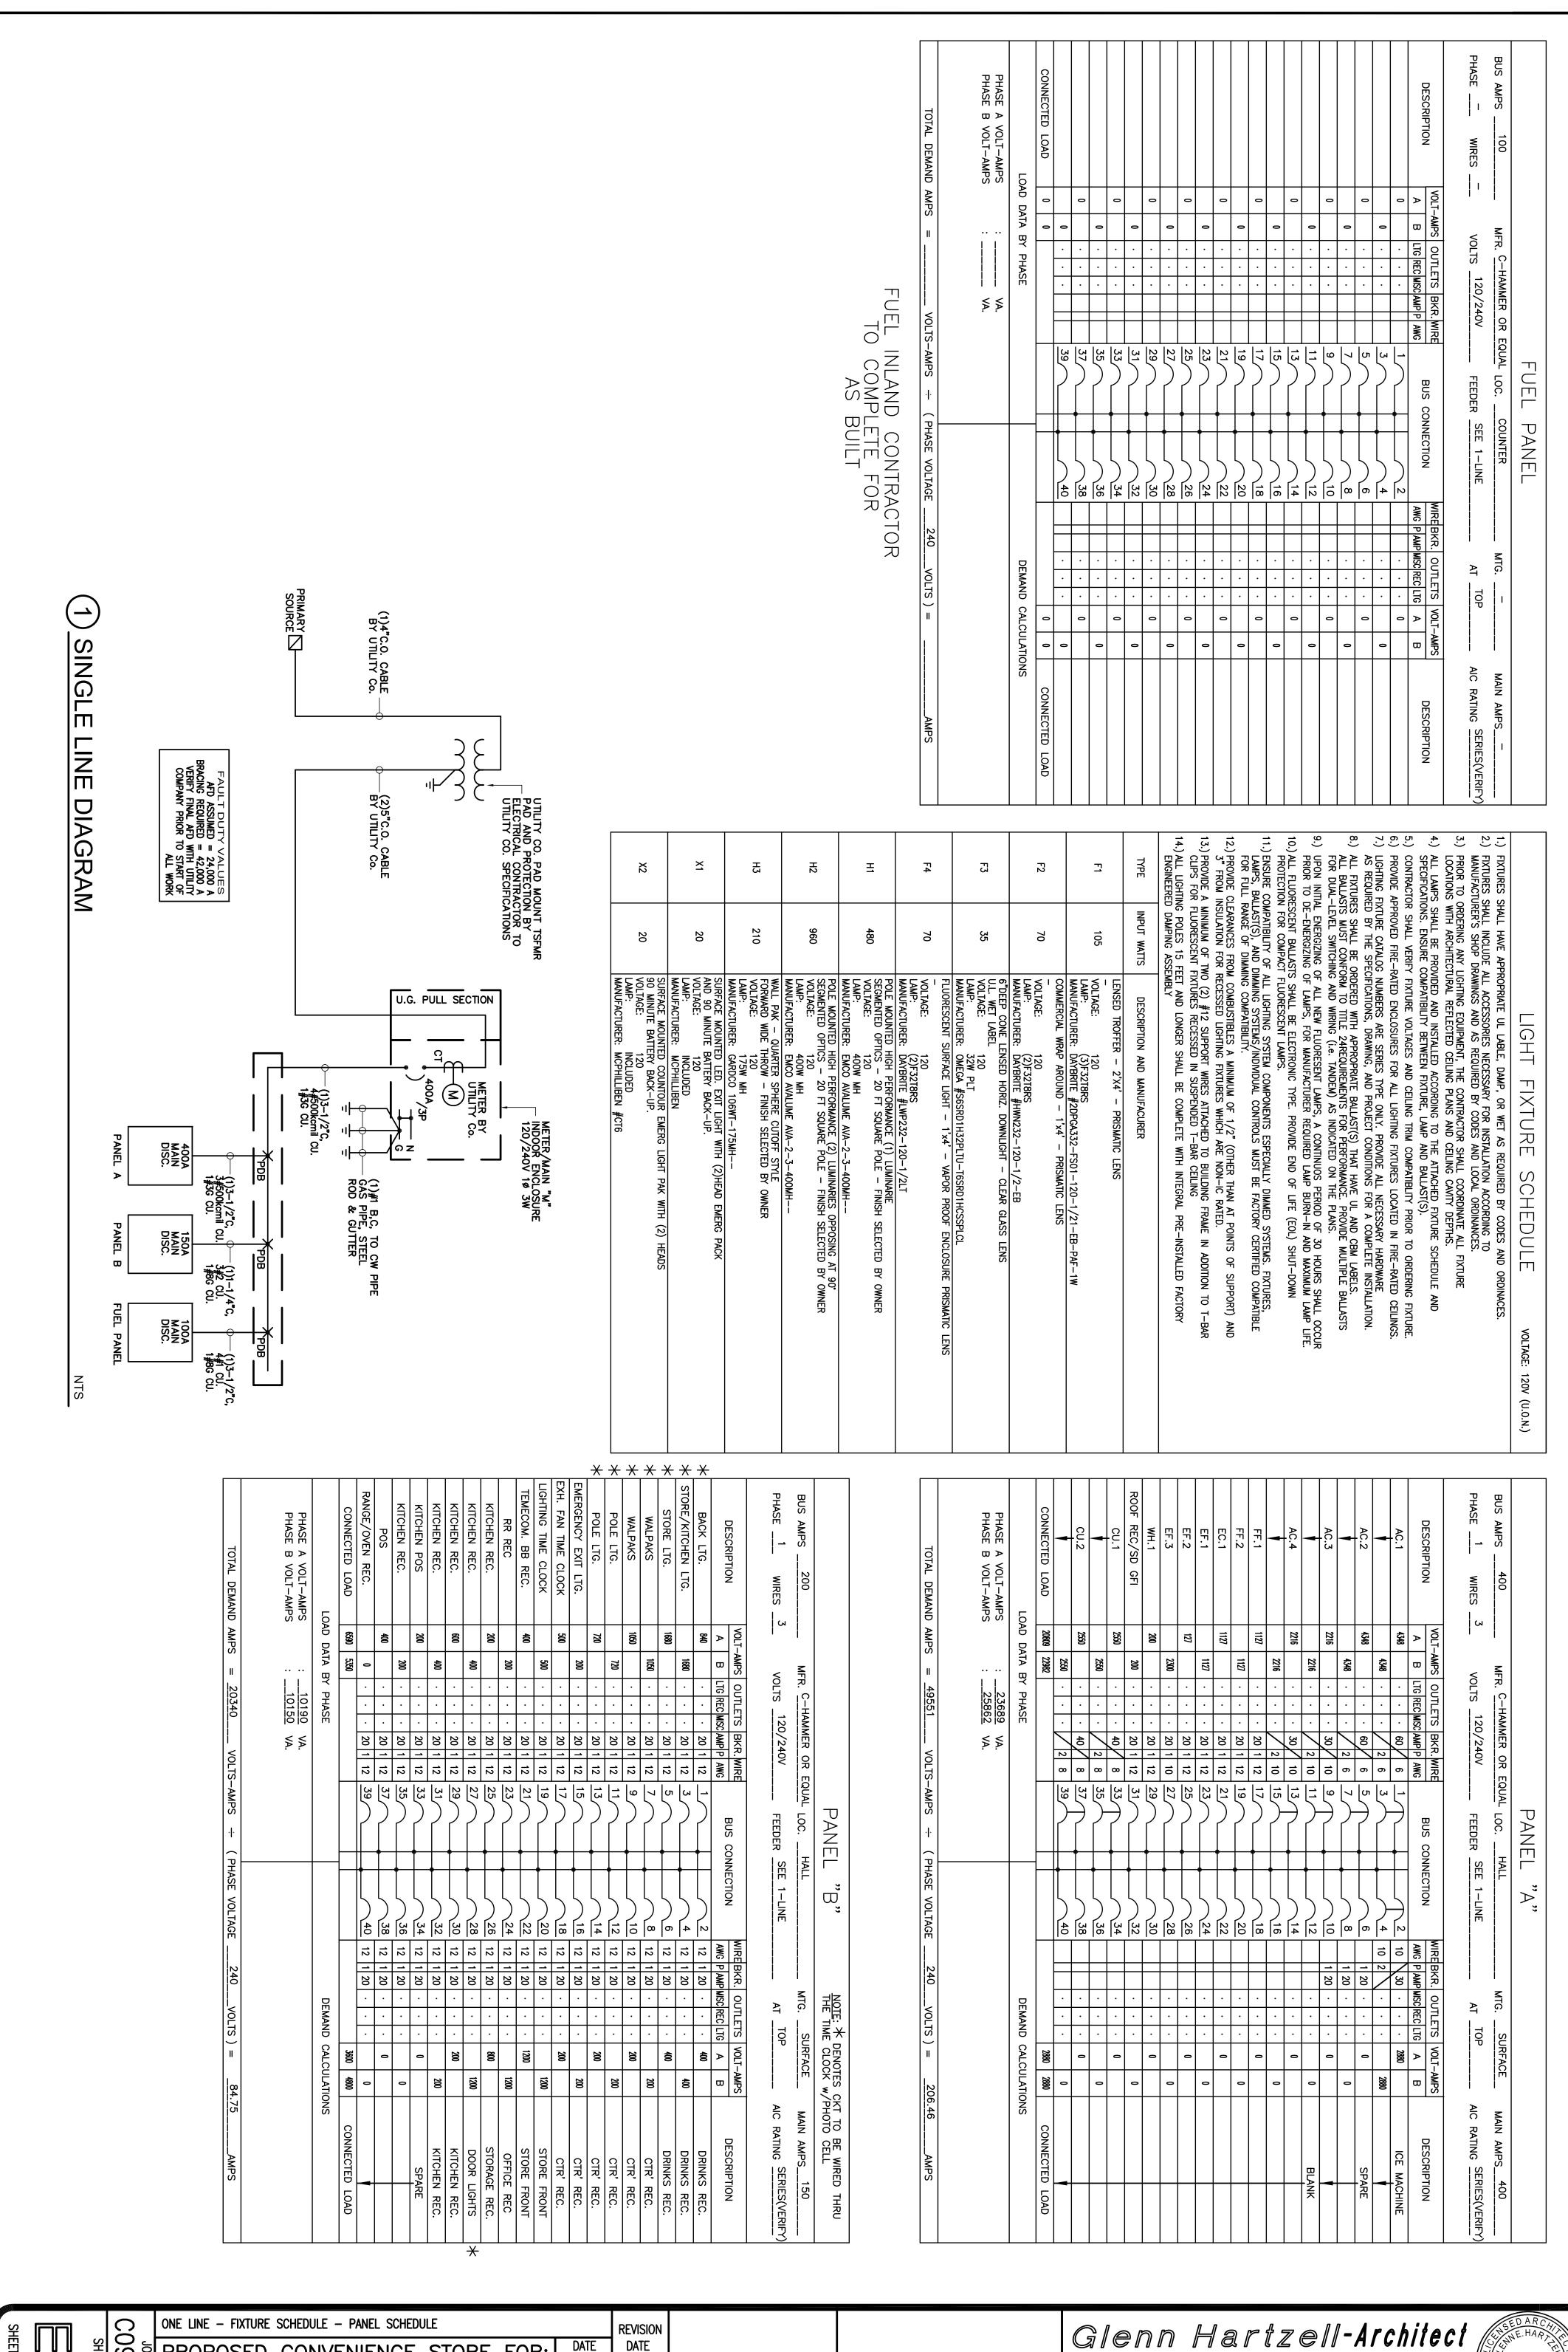

SHEET 유

WILLIES MARKET 05 690 N ELMWOOD AVE LINDSAY, CA

ONE LINE - FIXTURE SCHEDULE - PAINEL SUILDULE

ONE LINE - FIXTURE SCHEDULE - PAINEL SUILDULE


PROPOSED CONVENIENCE STORE FOR: 12/22/2009 DRAWN

12/18/09

Glenn Hartzell-Architect

1800 21st STREET, SUITE C BAKERSFIELD, CALIFORNIA 93301 ARCHITECT C-10298



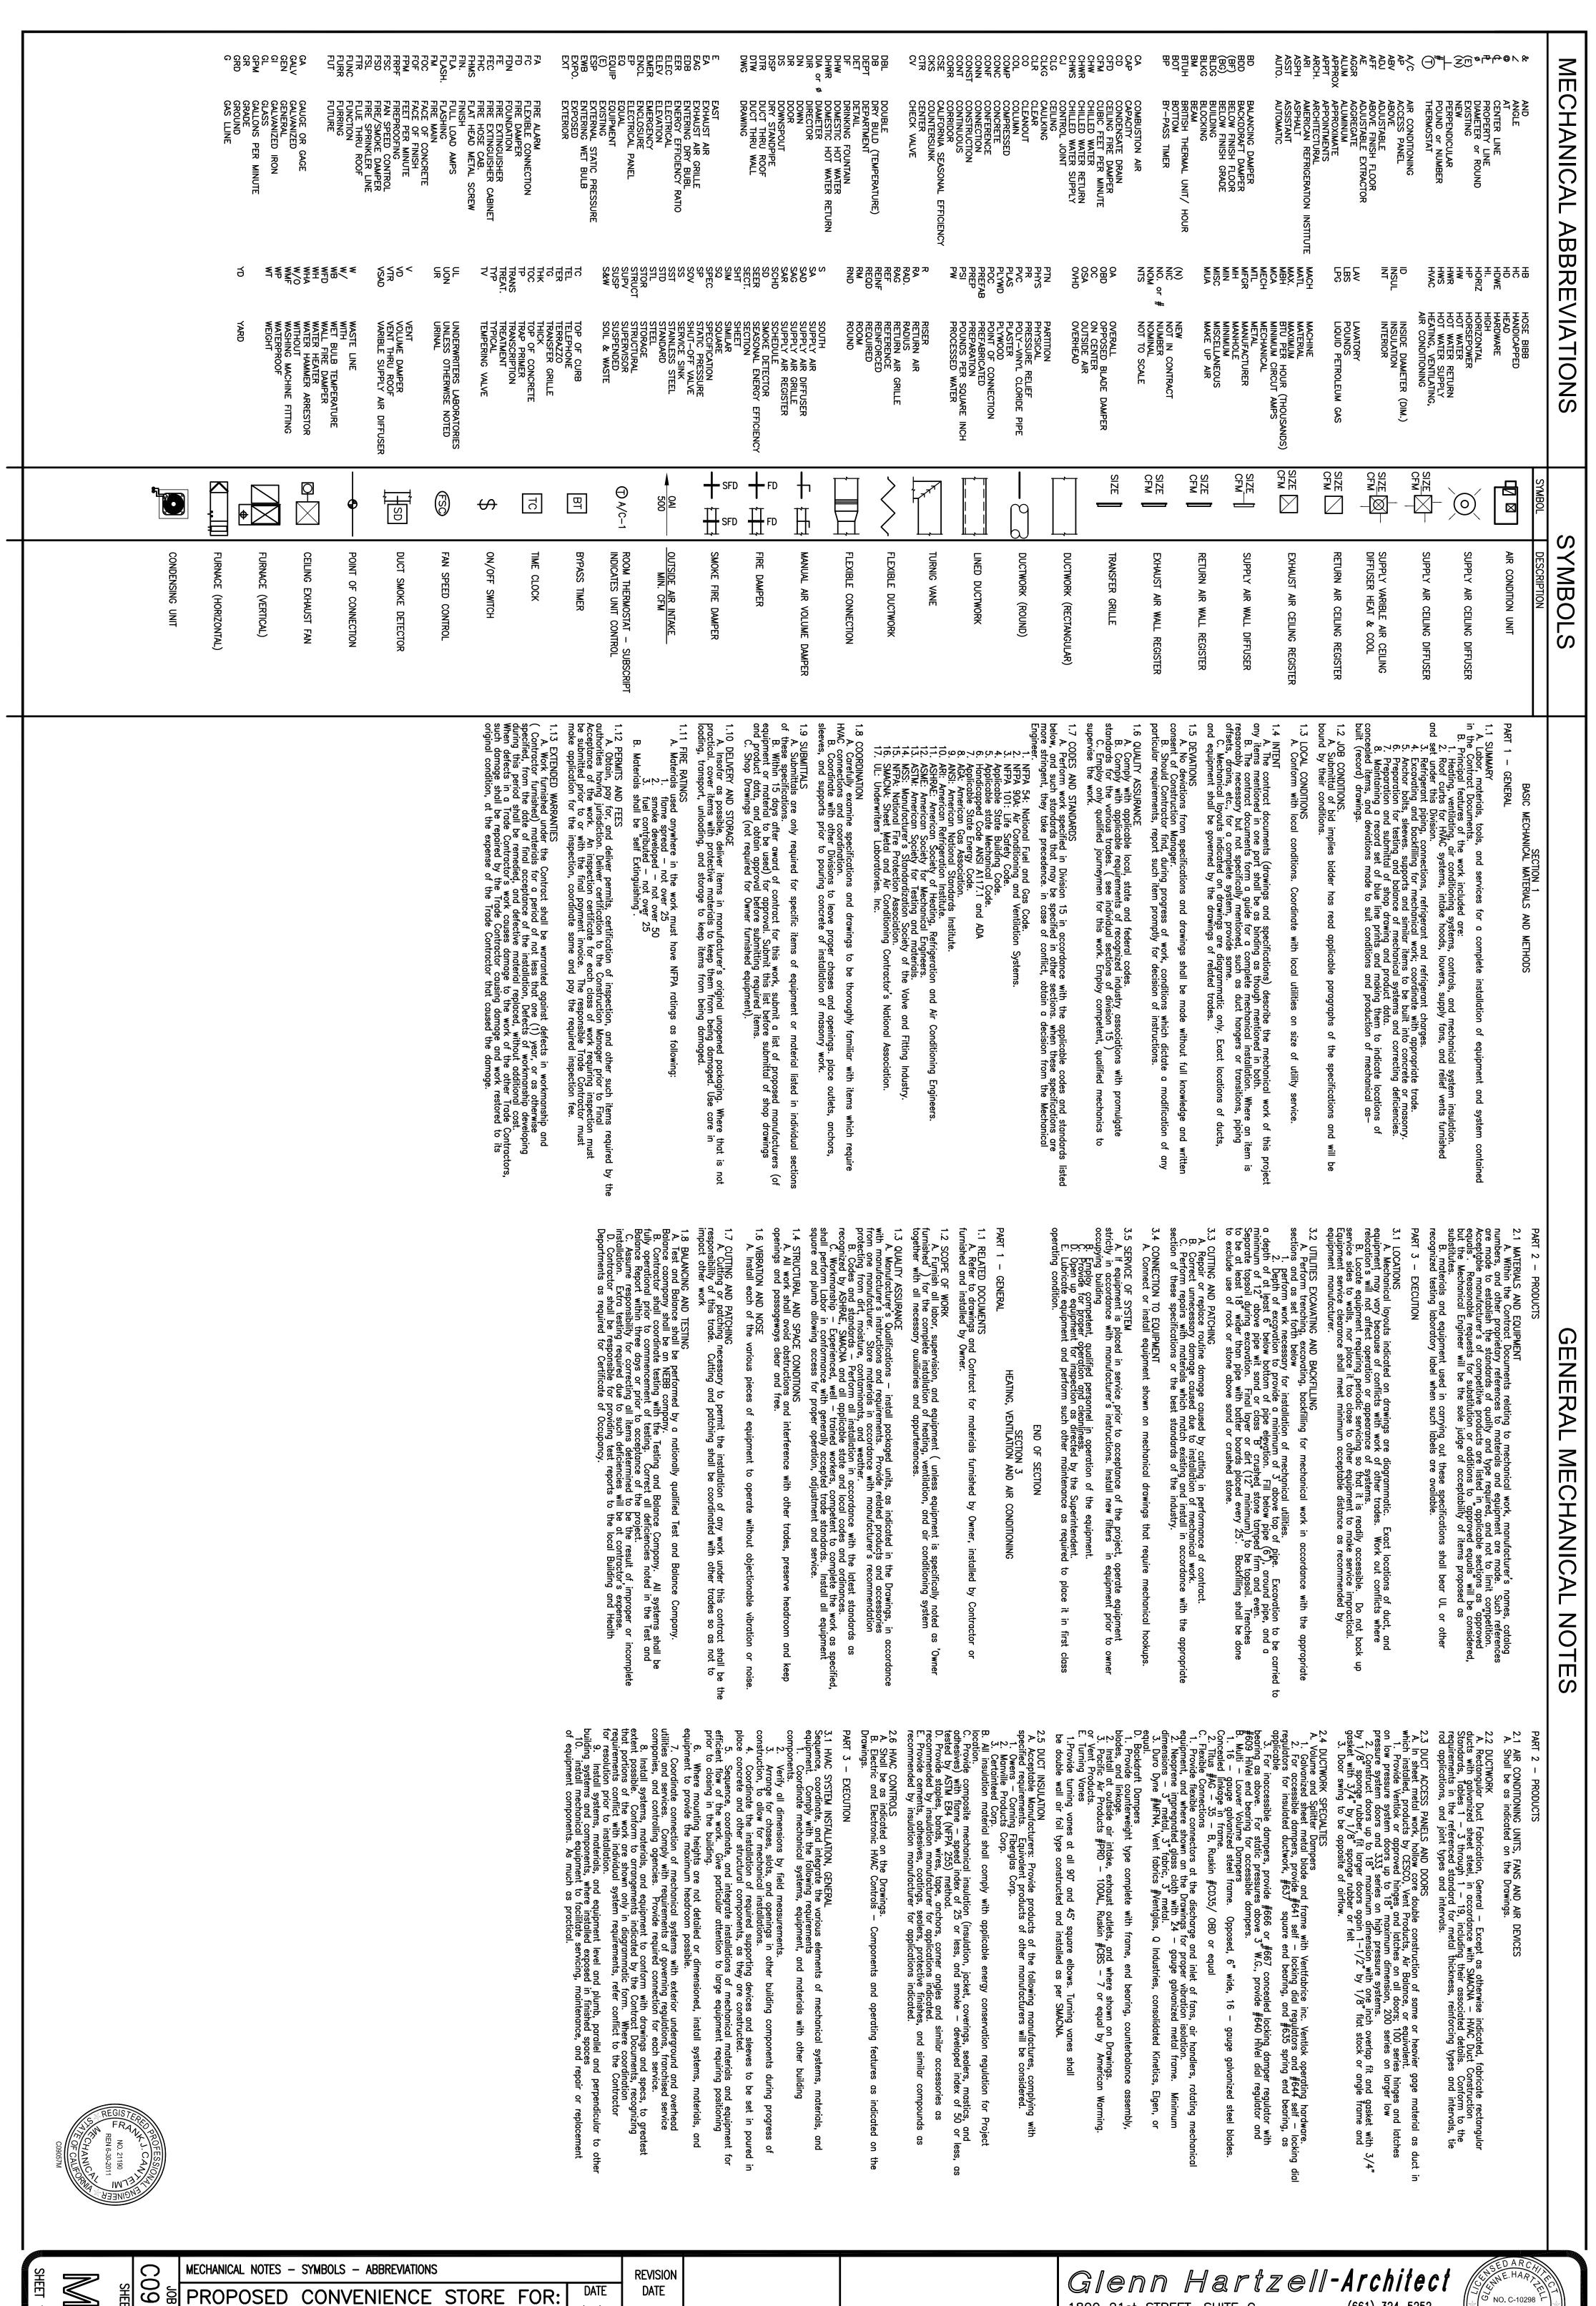

SHEET

05

WILLIES MARKET 690 N ELMWOOD AVE LINDSAY, CA


PROPOSED CONVENIENCE STORE FOR:


DATE 10/16/2009 12/18/09 DRAWN


1800 21st STREET, SUITE C BAKERSFIELD, CALIFORNIA 93301

(661) 324-5252 FAX (661) 324-8439 ARCHITECT C-10298



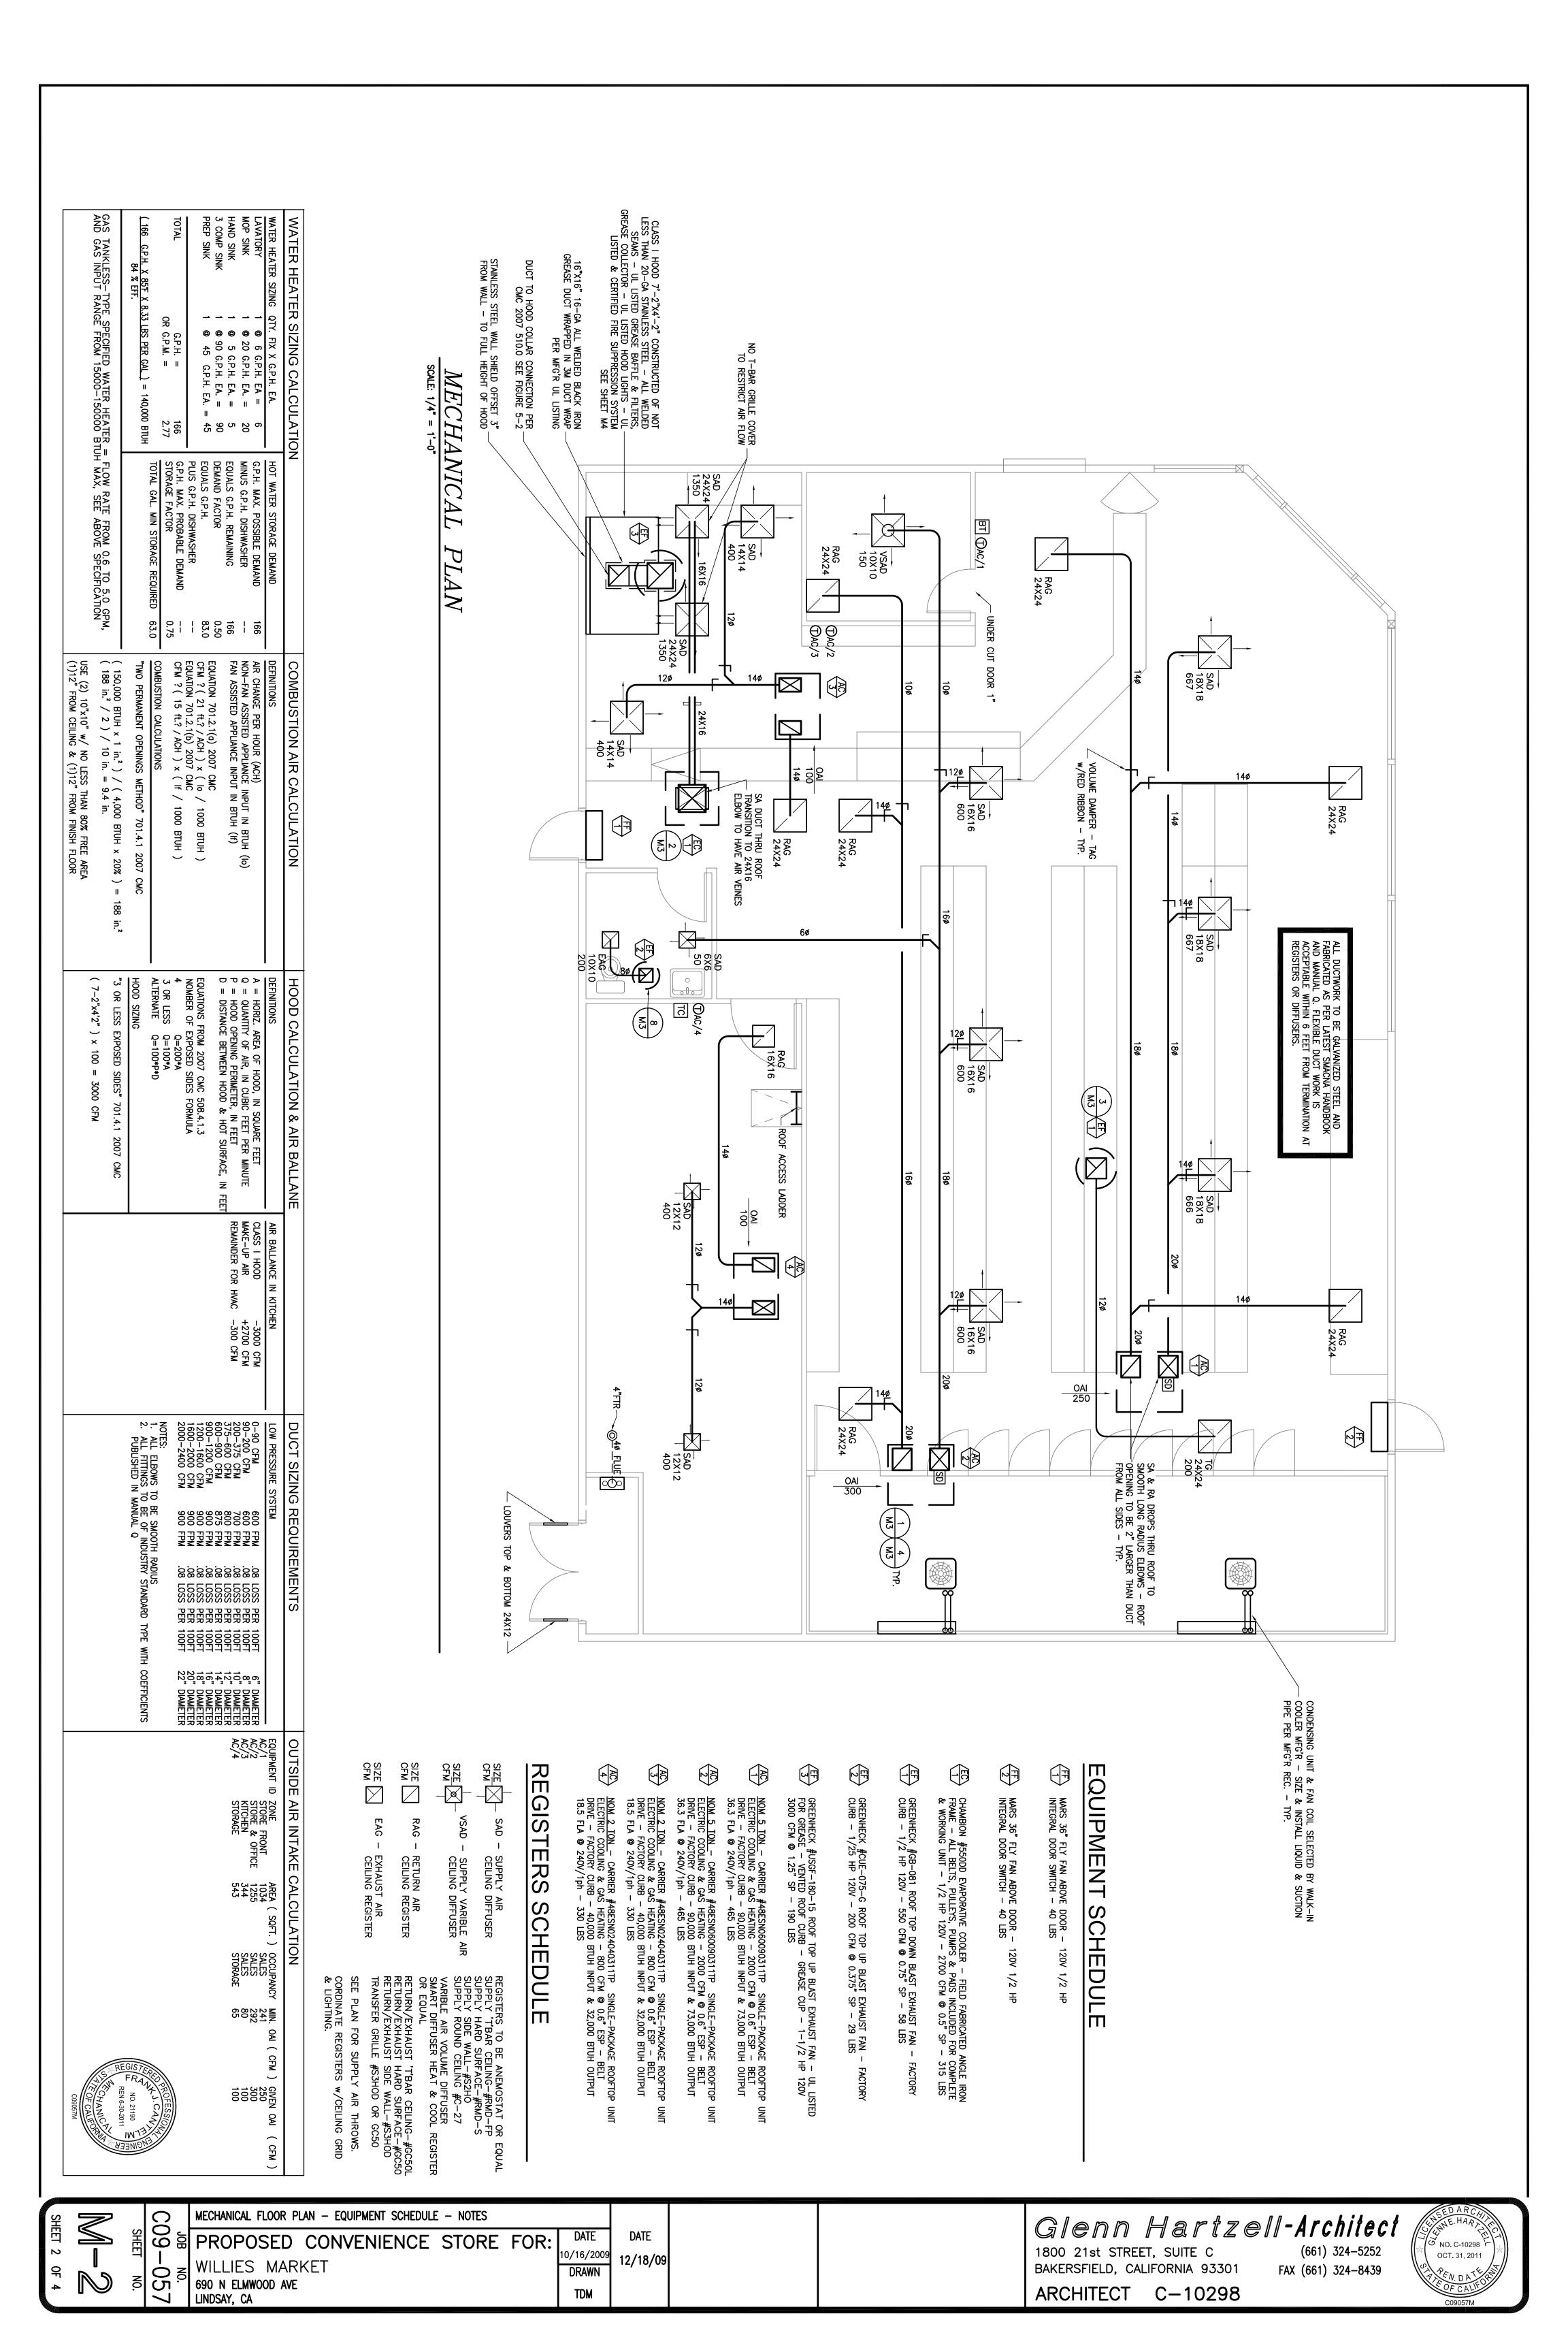

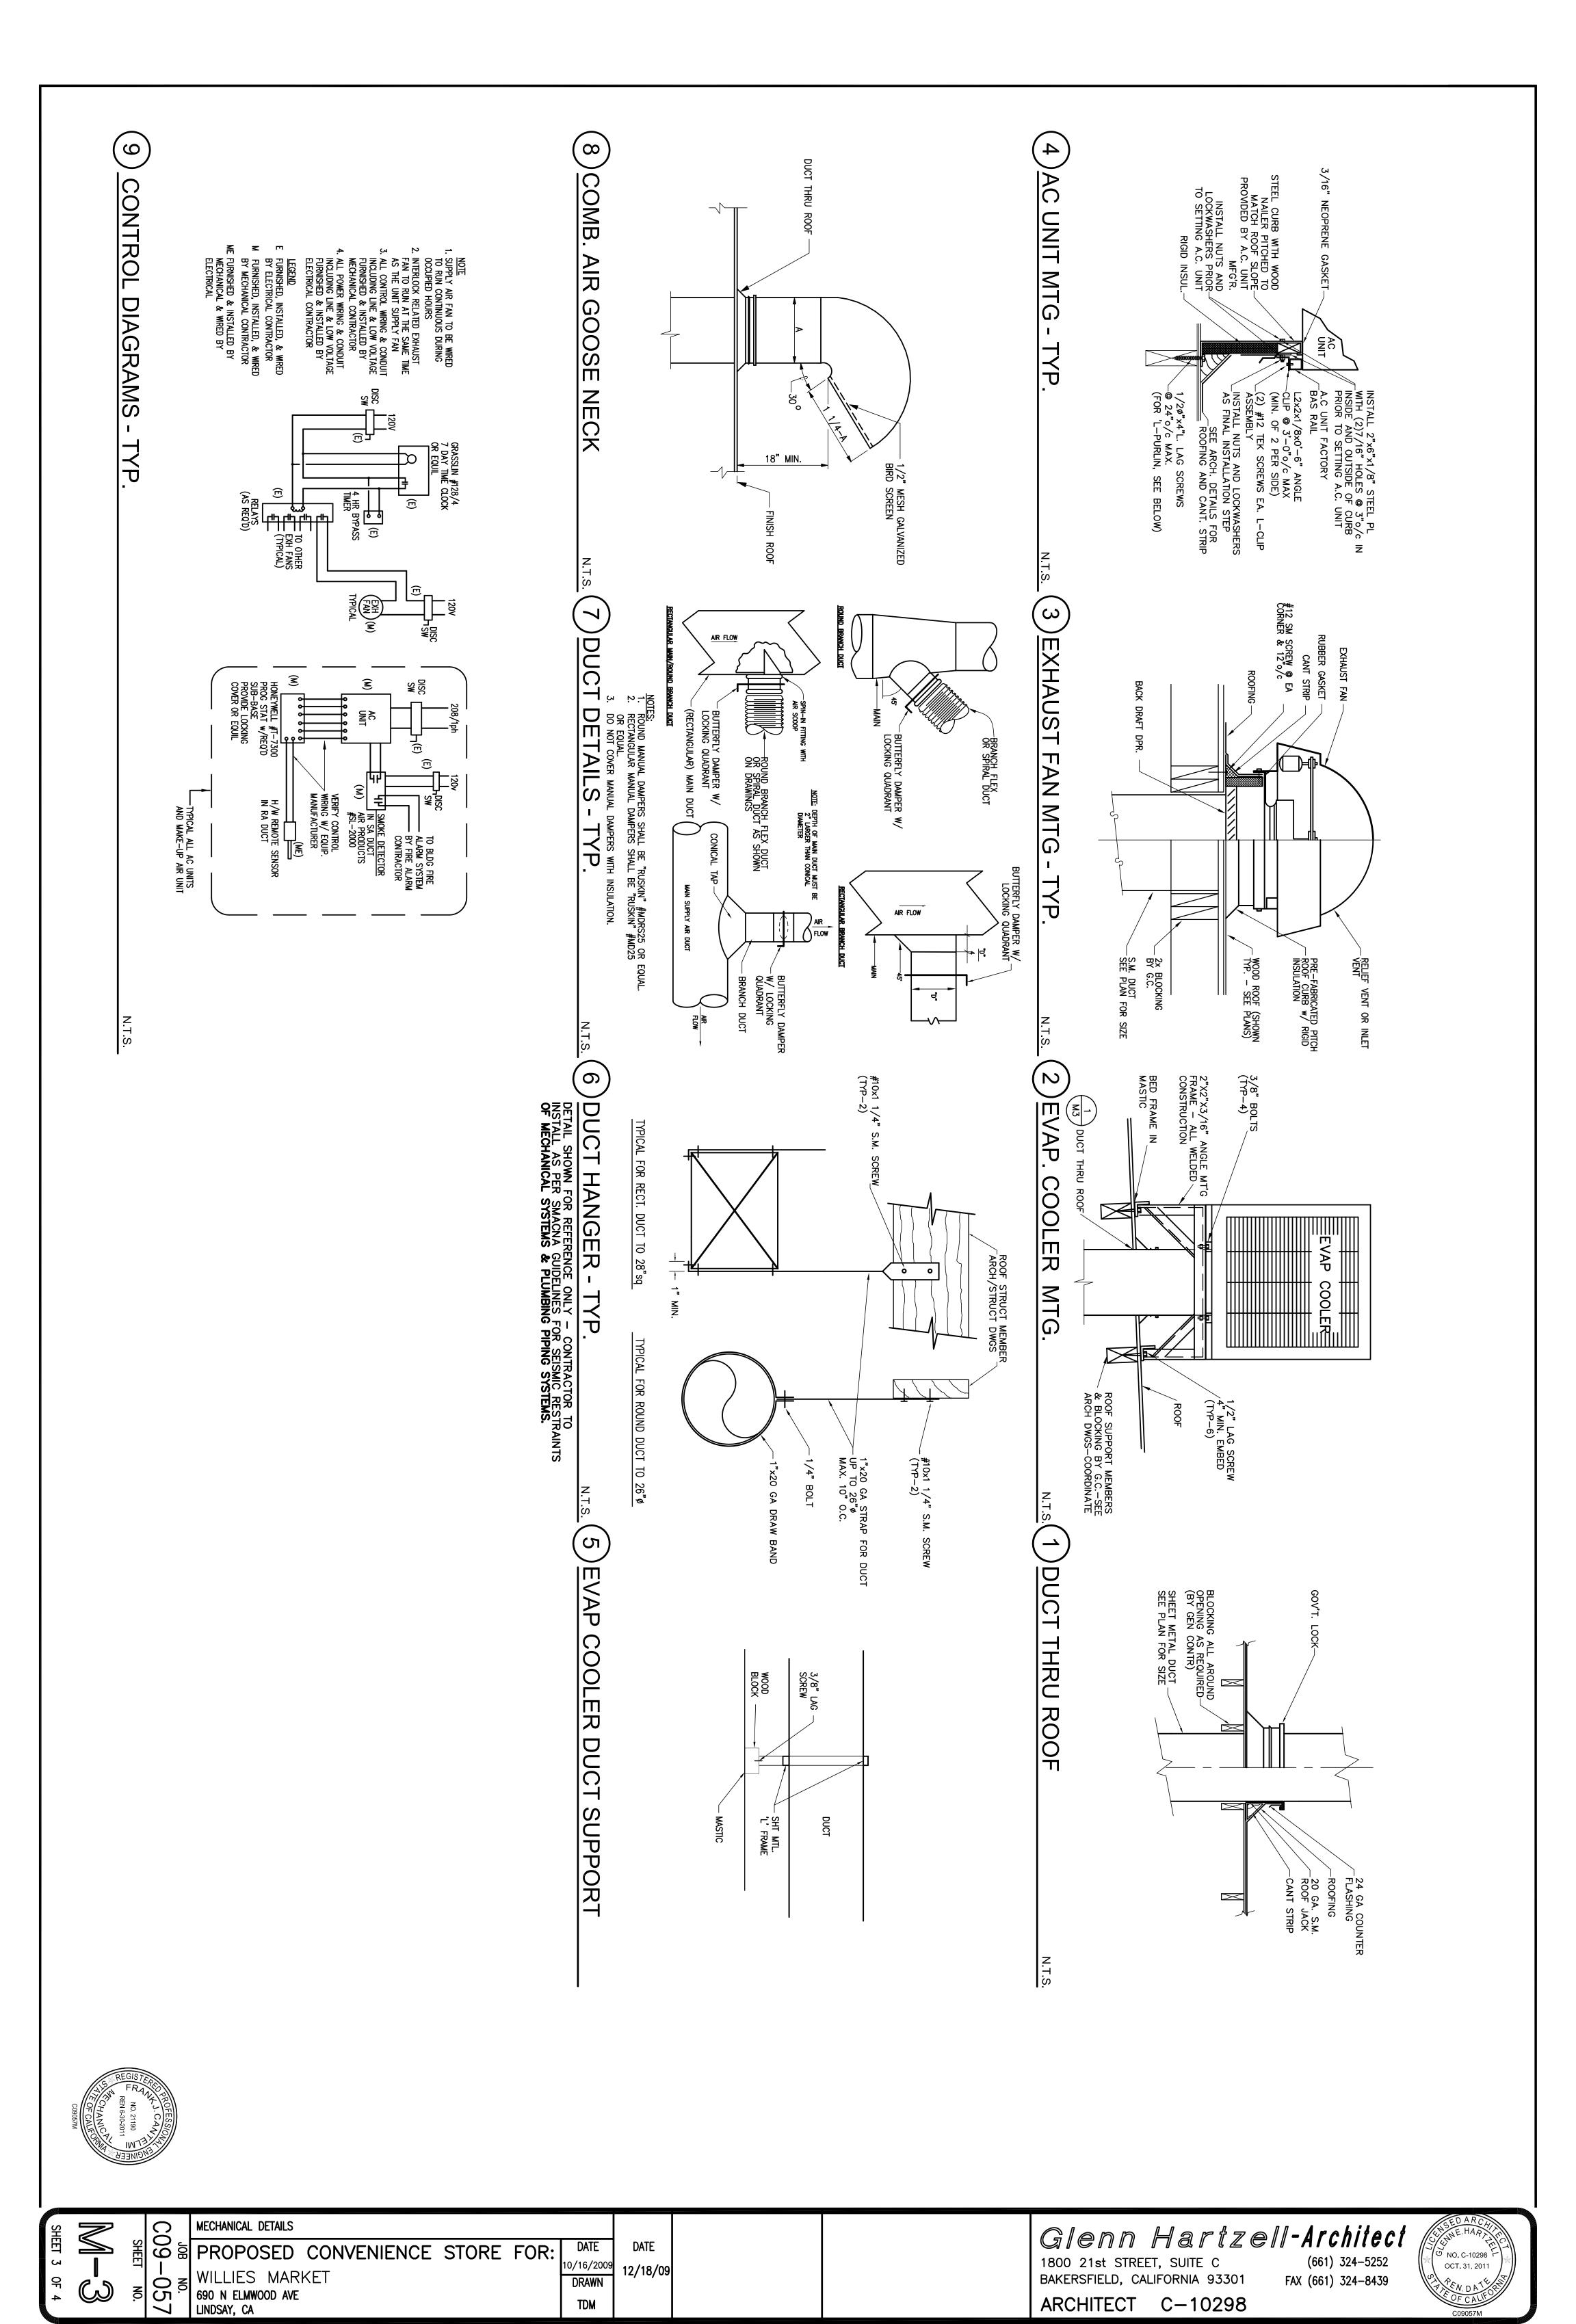

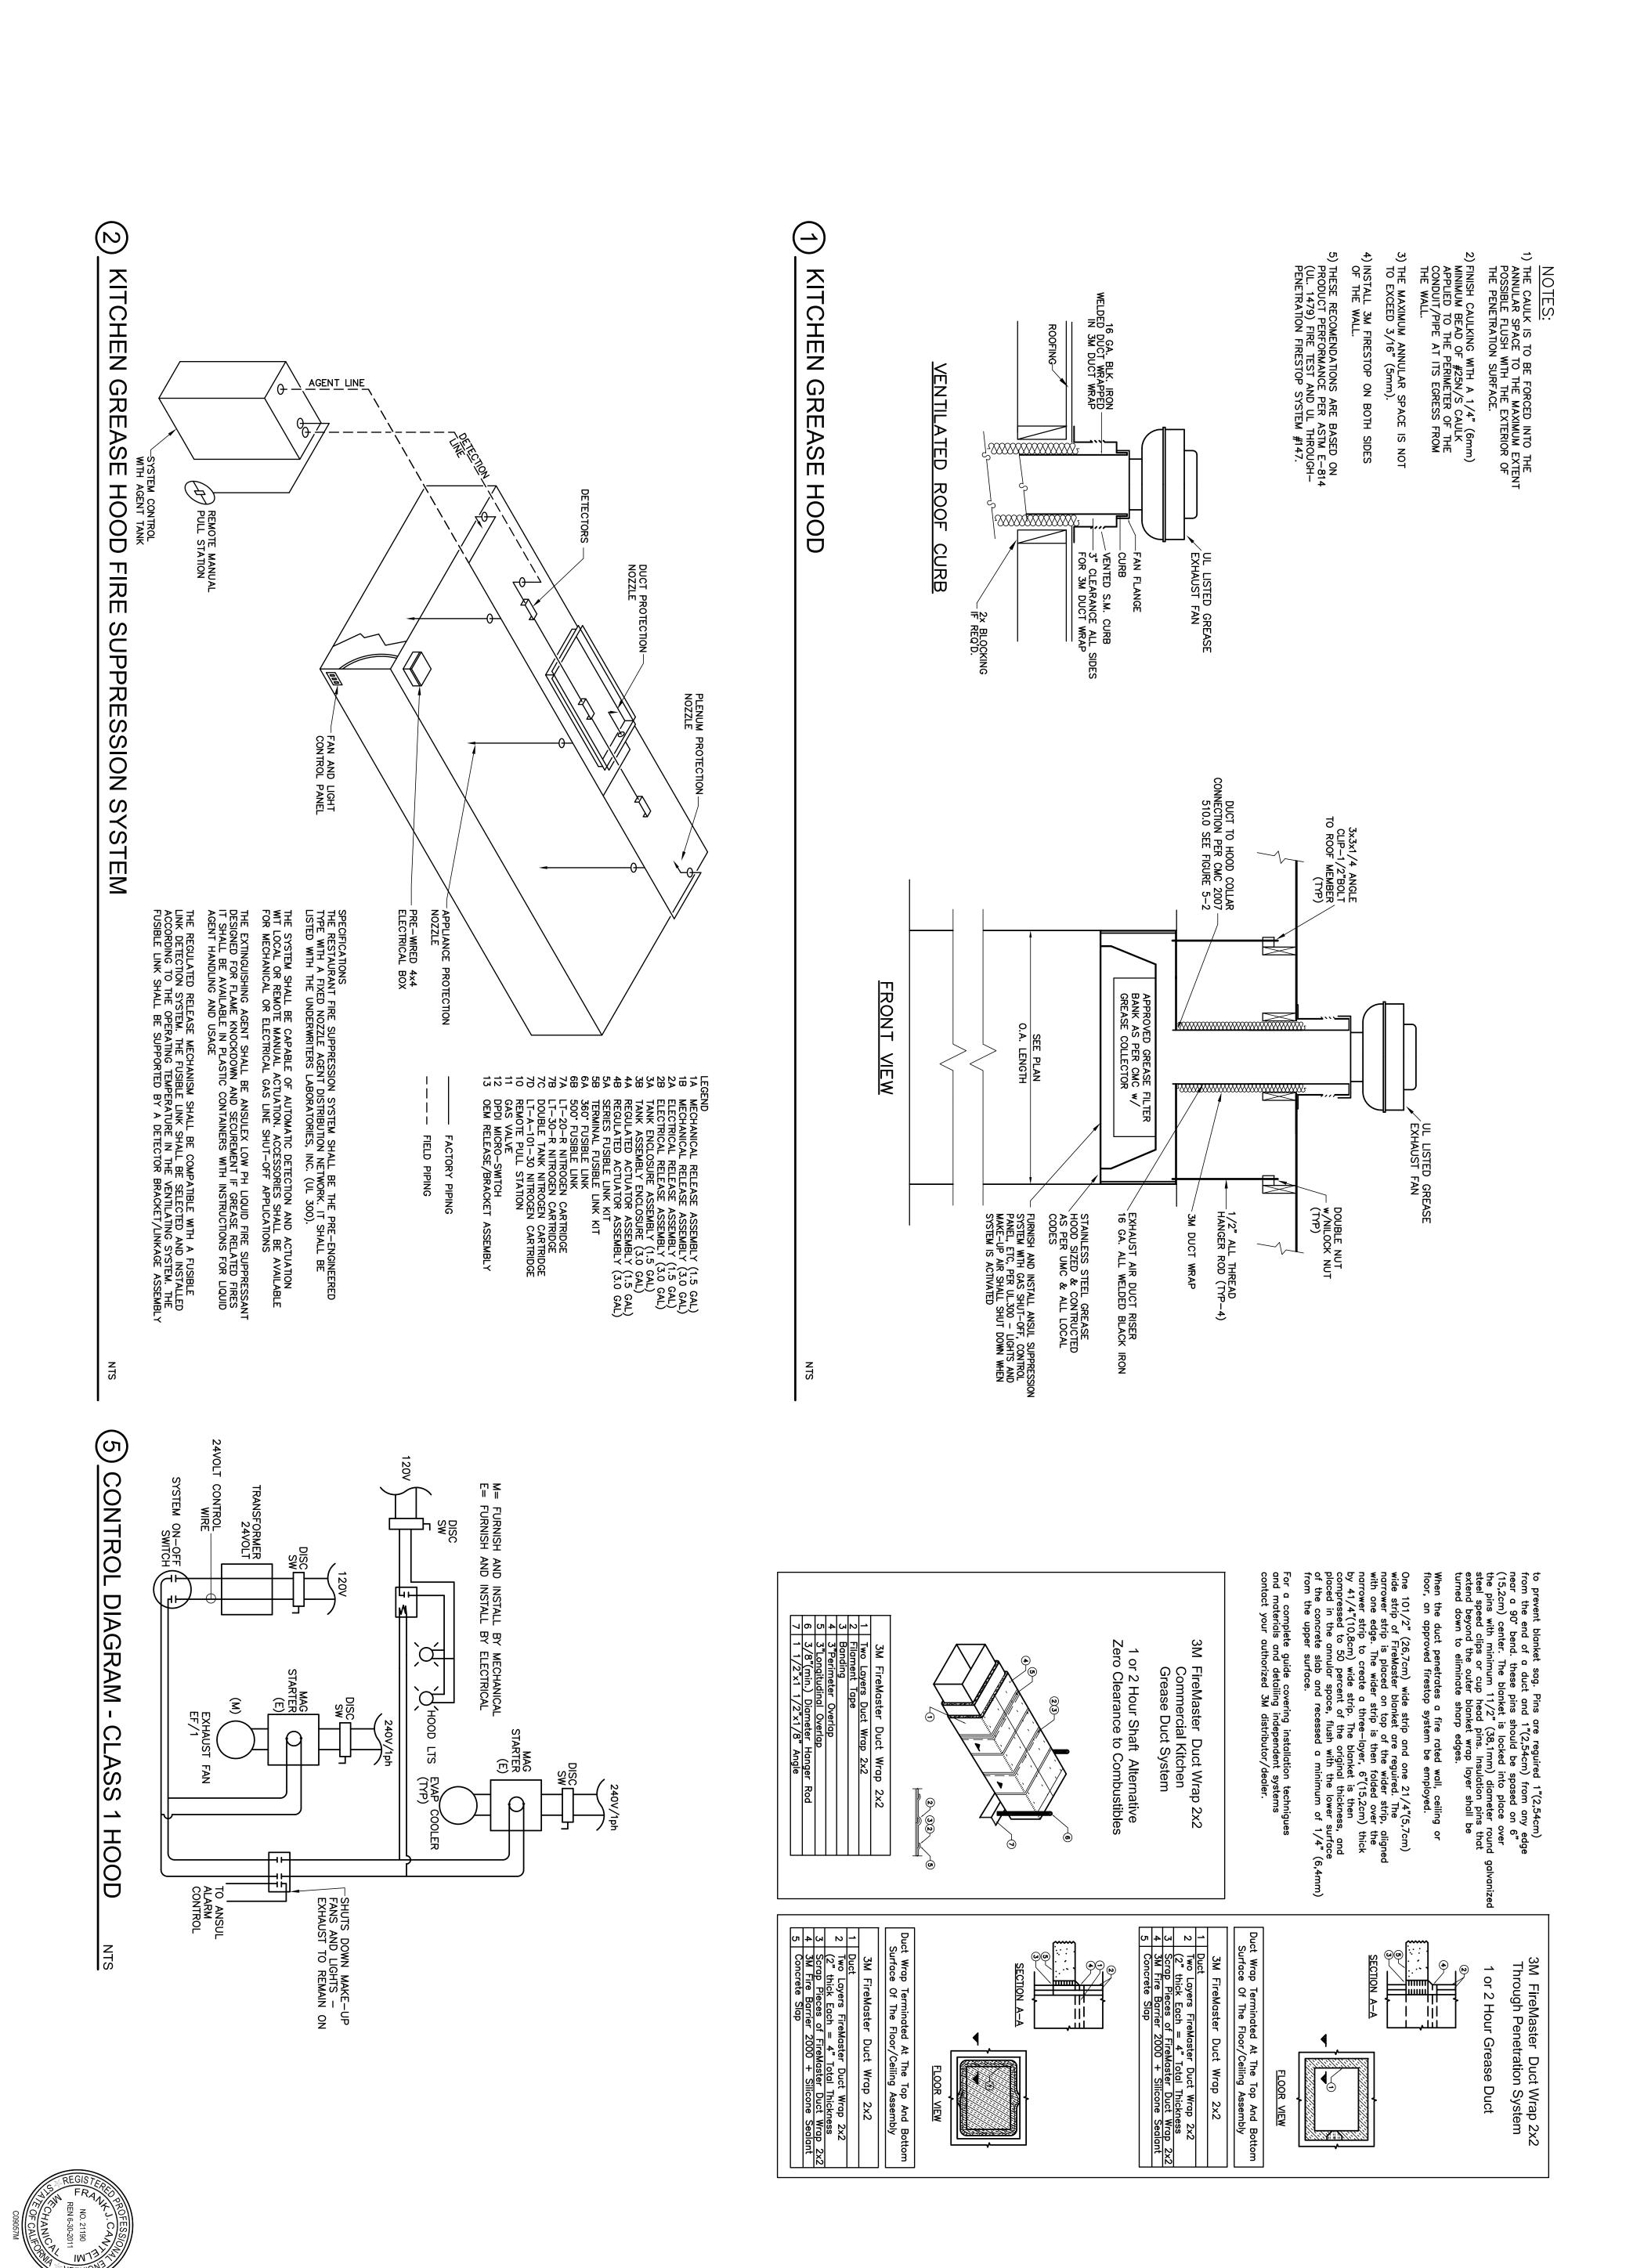

SHEET 4 유

EXHAUST HOOD DETAILS
PROPOSED CONVENIENCE STORE FOR: WILLIES MARKET 690 N ELMWOOD AVE LINDSAY, CA 05

EXHAUST HOOD DETAILS

DATE 12/18/09 DRAWN

Glenn Hartzell-Architect 1800 21st STREET, SUITE C BAKERSFIELD, CALIFORNIA 93301





-057


PLUMBING NOTES - SYMBOLS - ABBREVIATIONS PLUMBING NOTES - SYMBOLS - ABBREVIATIONS
PROPOSED CONVENIENCE STORE FOR: REVISION DATE 12/18/2009 DRAWN 12/18/09 WILLIES MARKET
690 N ELMWOOD AVE
LINDSAY, CA

Glenn Hartzell-Architect

(661) 324-5252 FAX (661) 324-8439 1800 21st STREET, SUITE C BAKERSFIELD, CALIFORNIA 93301 ARCHITECT C-10298





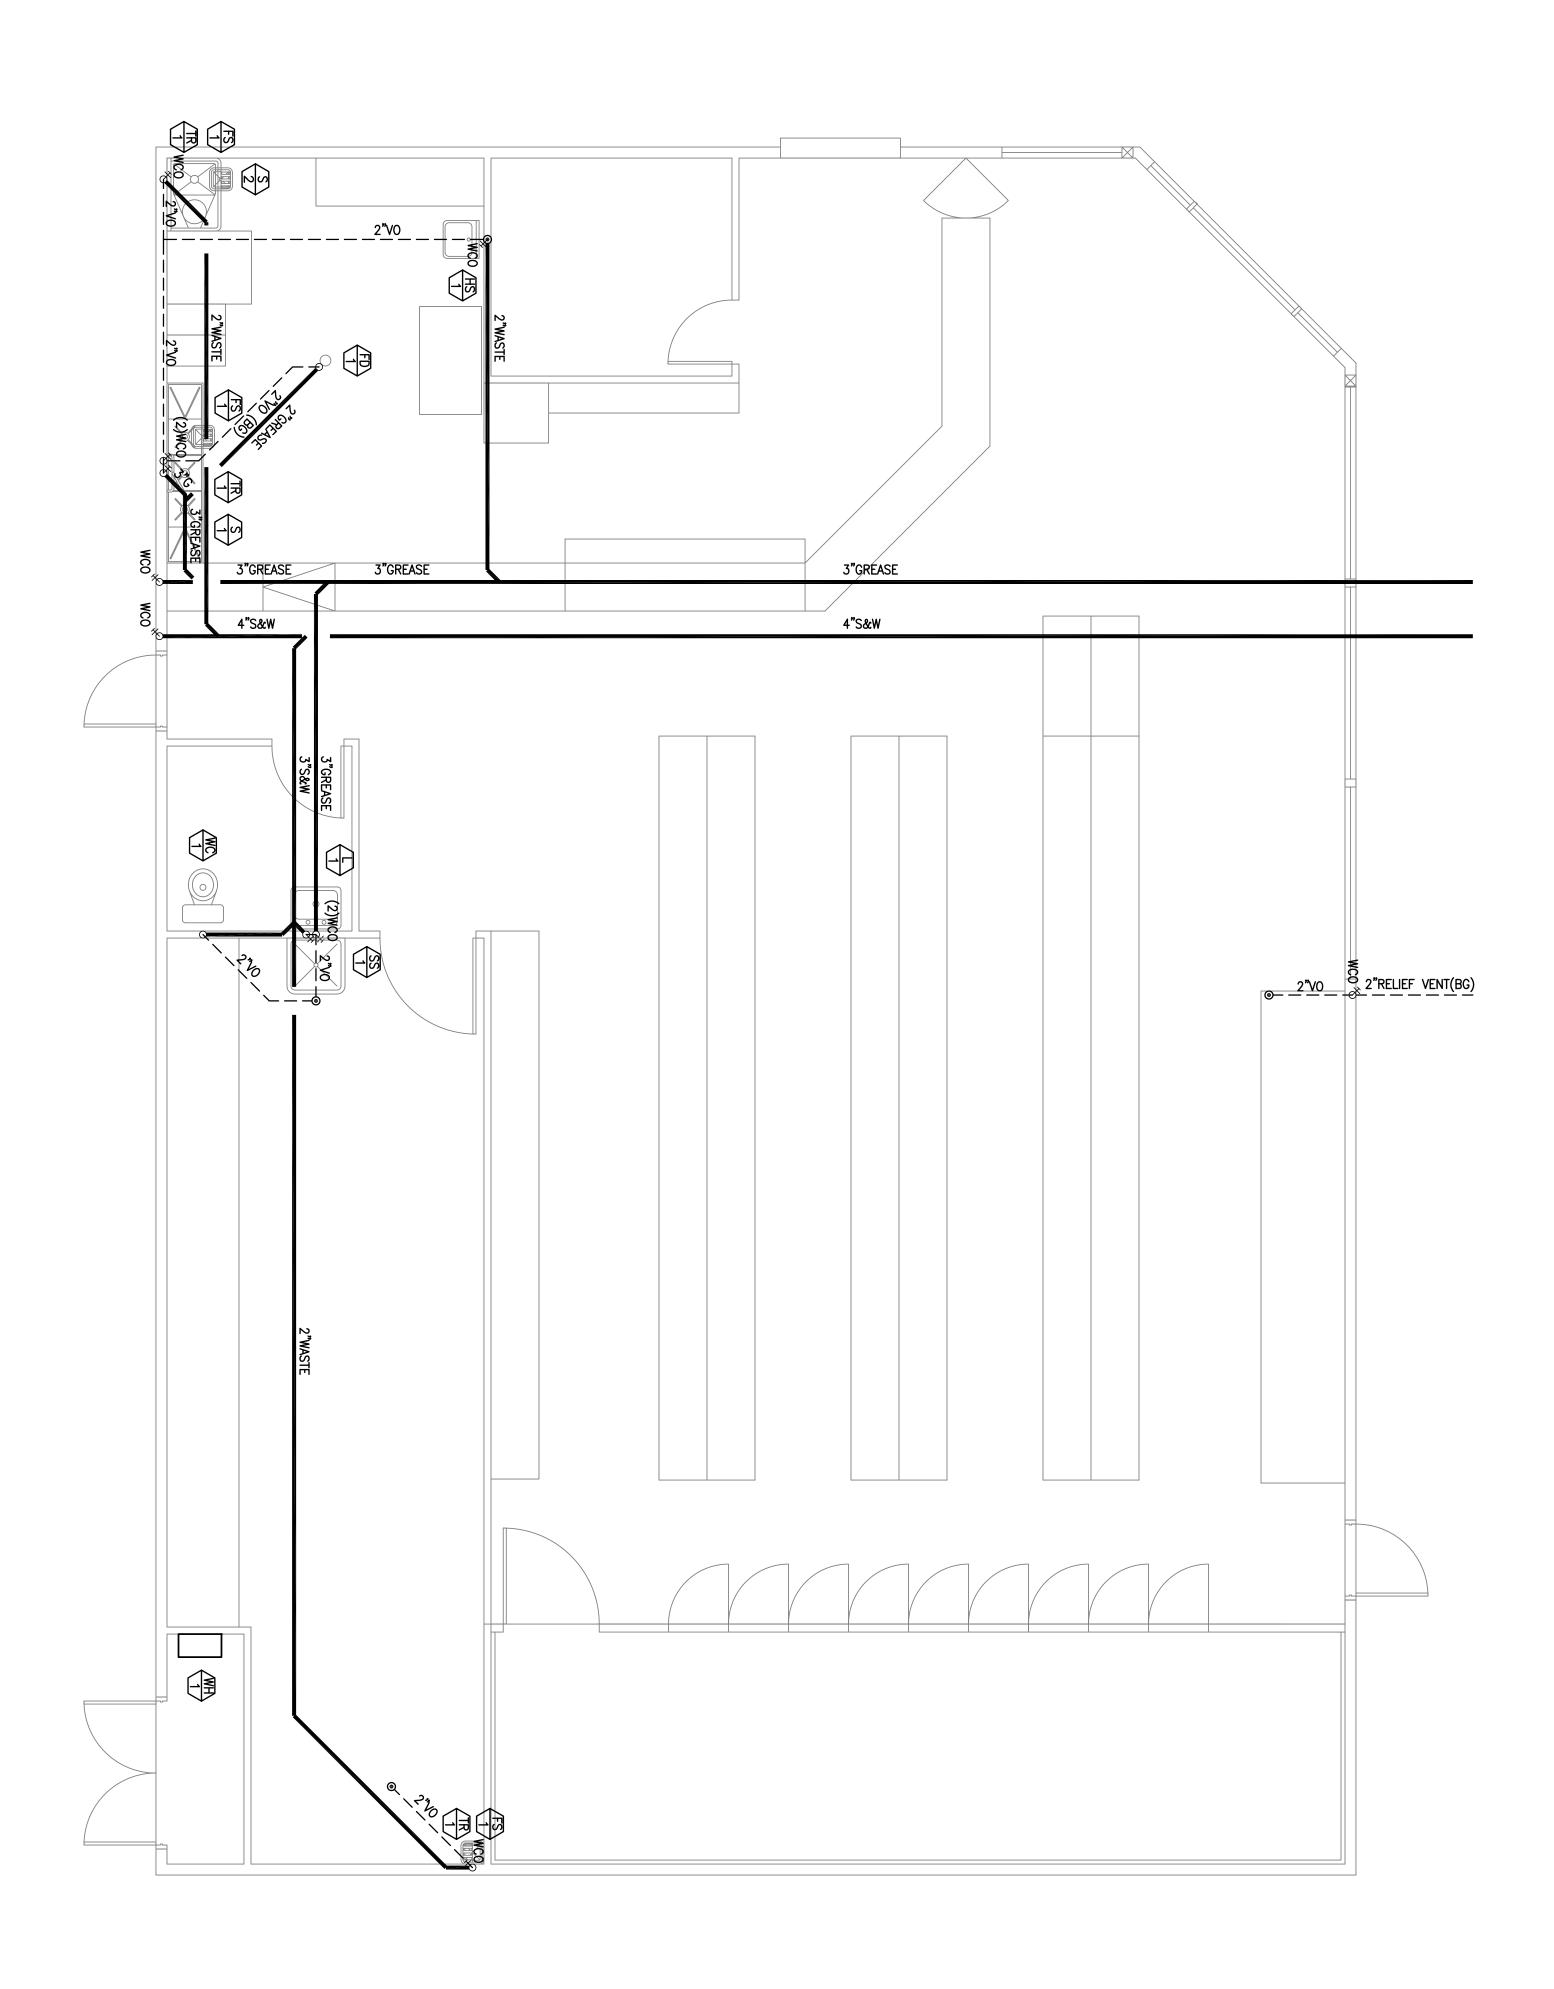

NOTE TO CONTRACTOR:

1. ALL SOIL, WASTE, VENT & DRAIN PIPING TO HAVE 2% MIN SLOPE (1/4" DROP PER FOOT SLOPE)

2. ALL VENTS SHALL TERMINATE THRU ROOF NO LESS THAN (10) FEET FROM AND/OR AT LEAST (3) FEET ABOVE ANY WINDOW, DOOR OPENING, AIR INTAKE OR VENT SHALL RISE VERTICALLY TO A POINT NOT LESS THAT (6) INCHES IN HEIGHT ABOVE THE FLOOD LEVEL RIM OF THE FIXTURE BEFORE BEING CONNECTED TO ANY OTHER VENT.


4. ALL FLOOR SINKS & FLOOR DRAINS TO HAVE 'P'-TRAP w/TRAP PRIMER CONNECTION.

5. ALL SINKS AND LAVS TO HAVE WALL CLEAN OUTS.

6. ALL WALL CLEAN OUTS TO BE FLUSH TO FINISH WALL.



HS	C	PLUMBING FLOOR PLAN - SEWER	REVISION	Clama Hartzall-Architact	SED ARCHING
EET 2 OF 5	' I	PROPOSED CONVENIENCE STORE FOR:  WILLIES MARKET 690 N ELMWOOD AVE  DAT 12/18/ DRAW	E DATE <sup>2009</sup> 12/18/0	1800 21st STREET, SUITE C (661) 324-5252 BAKERSFIELD, CALIFORNIA 93301 FAX (661) 324-8439	OCT. 31, 2011  OF CALIFORNIA
	·   57	LINDSAY, CA		ARCHITECT C-10298	C09057P

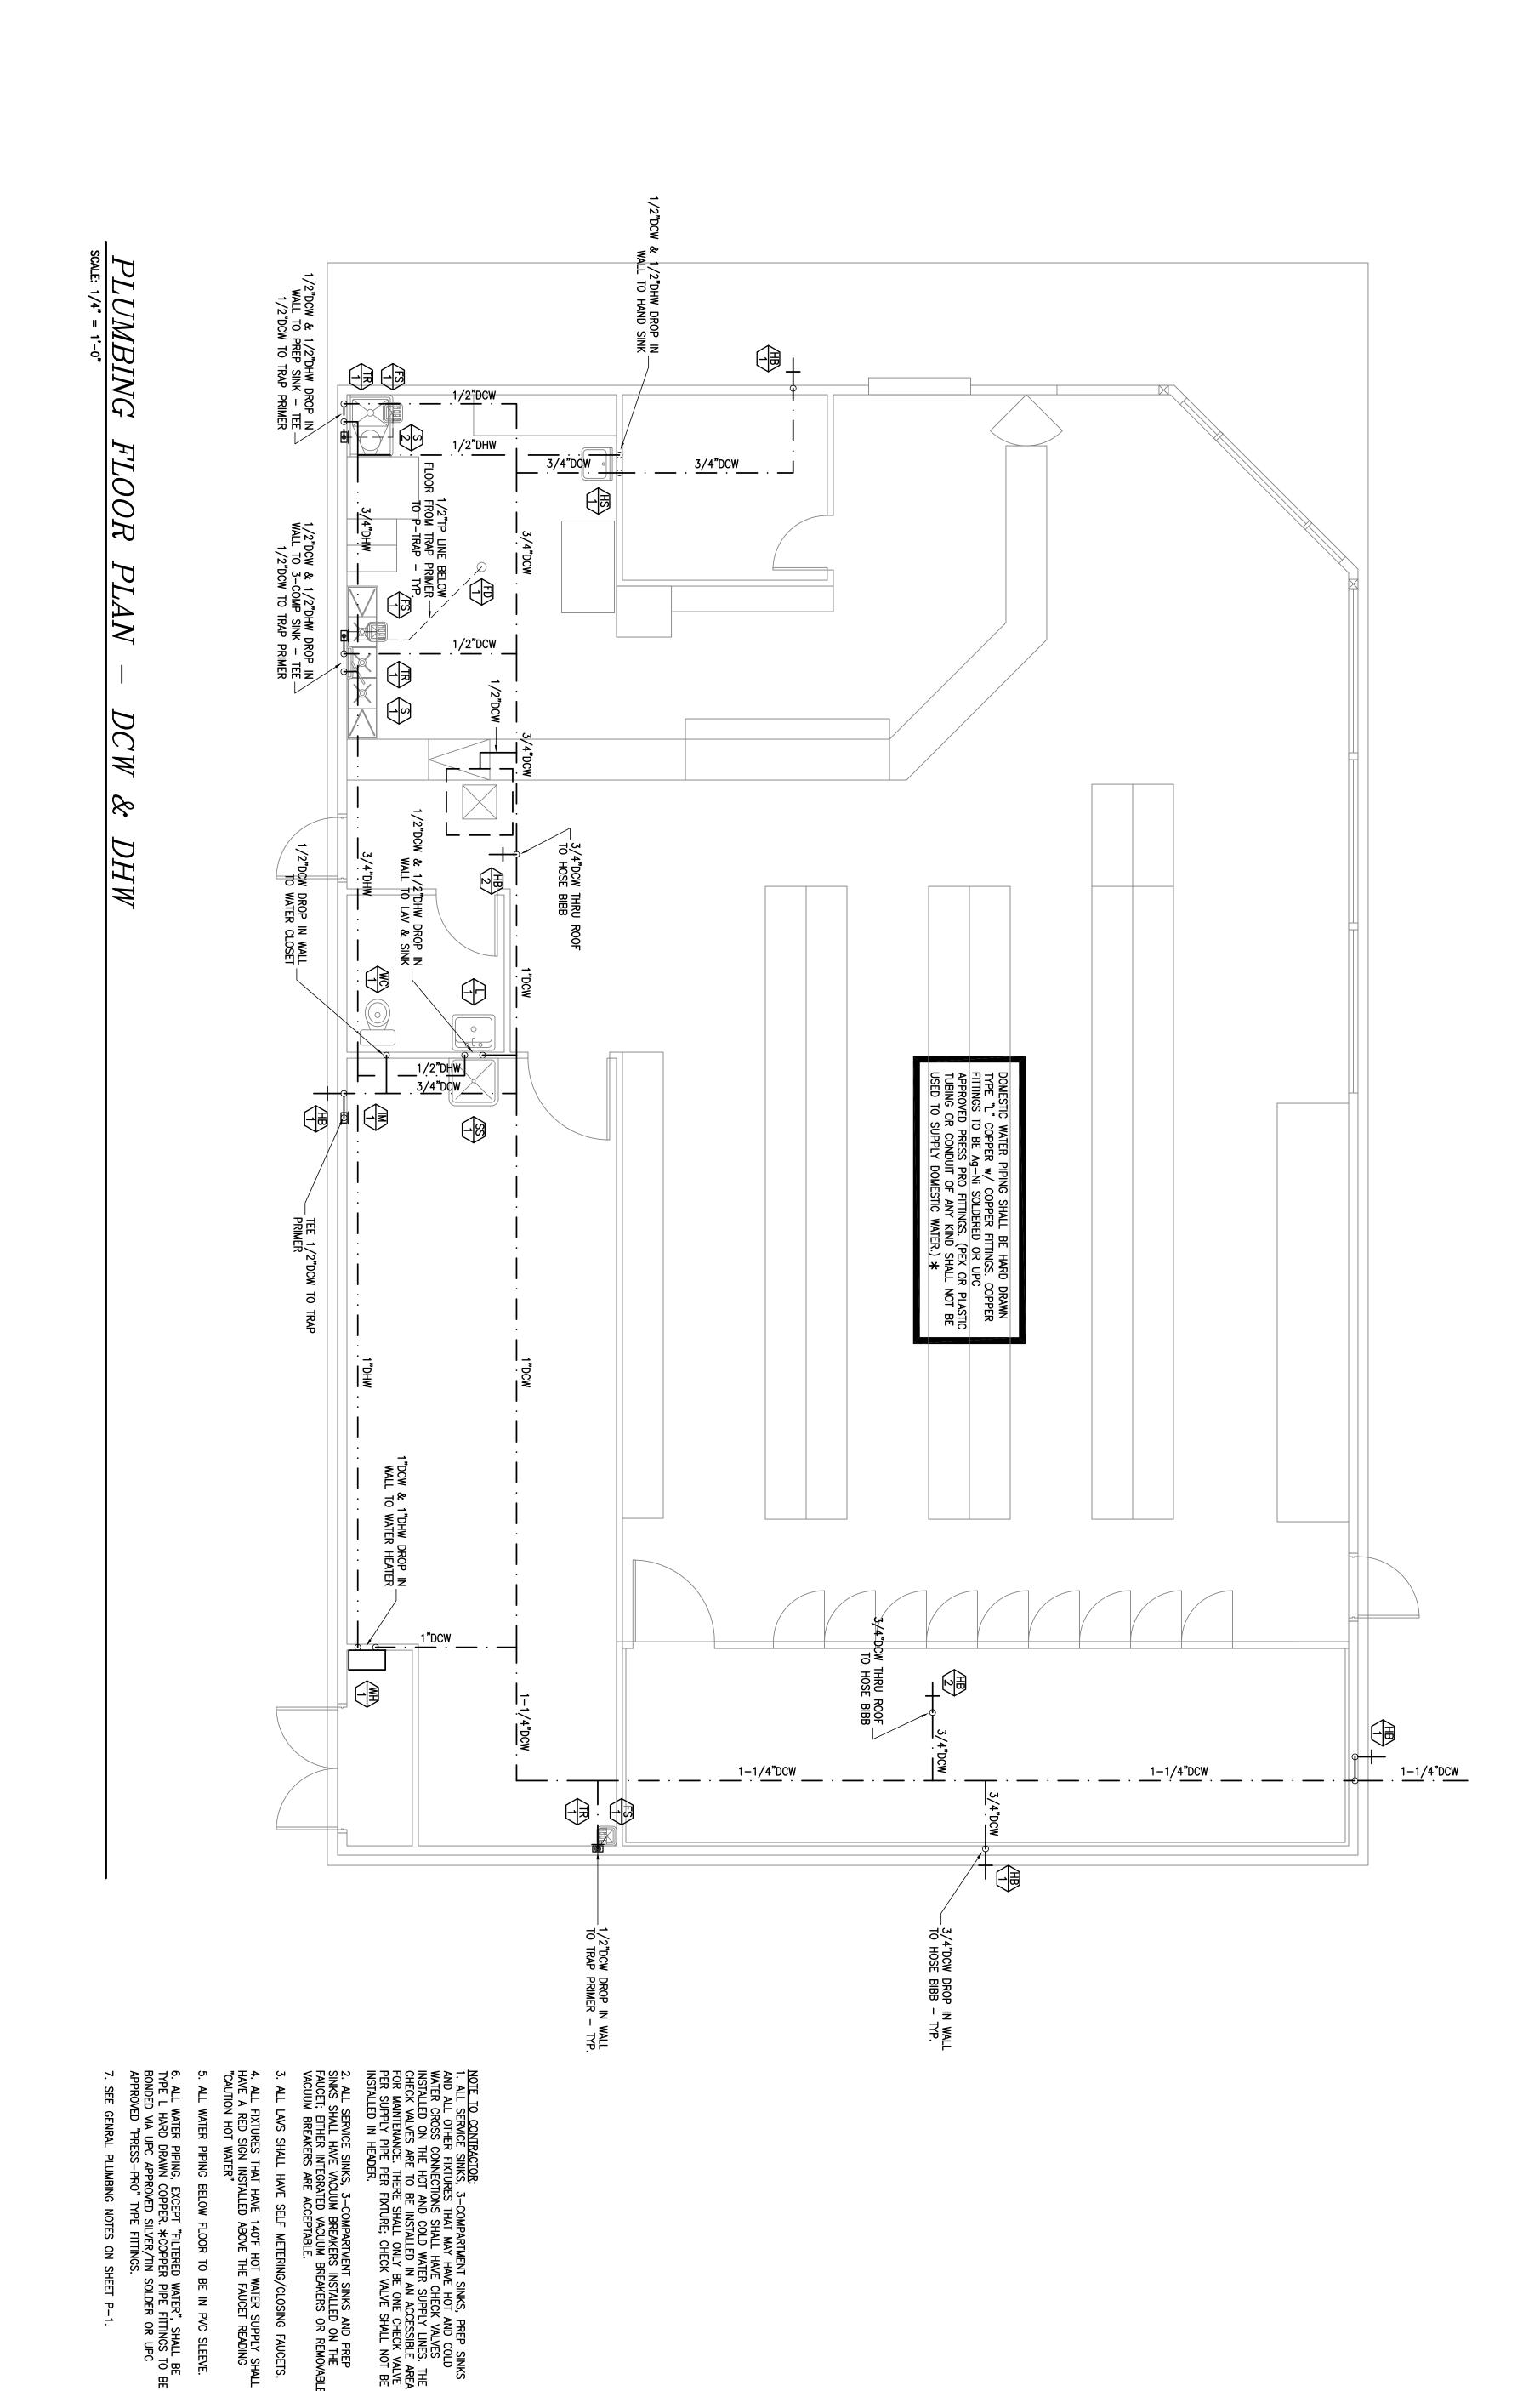




PROPOSED CONVENIENCE STORE FOR: DATE 12/18/2009 DRAWN A.F.

PROPOSED CONVENIENCE STORE FOR: DATE 12/18/2009 DRAWN A.F.

PROPOSED CONVENIENCE STORE FOR: DATE 12/18/2009 DRAWN A.F.

ARCHITECT C-10298

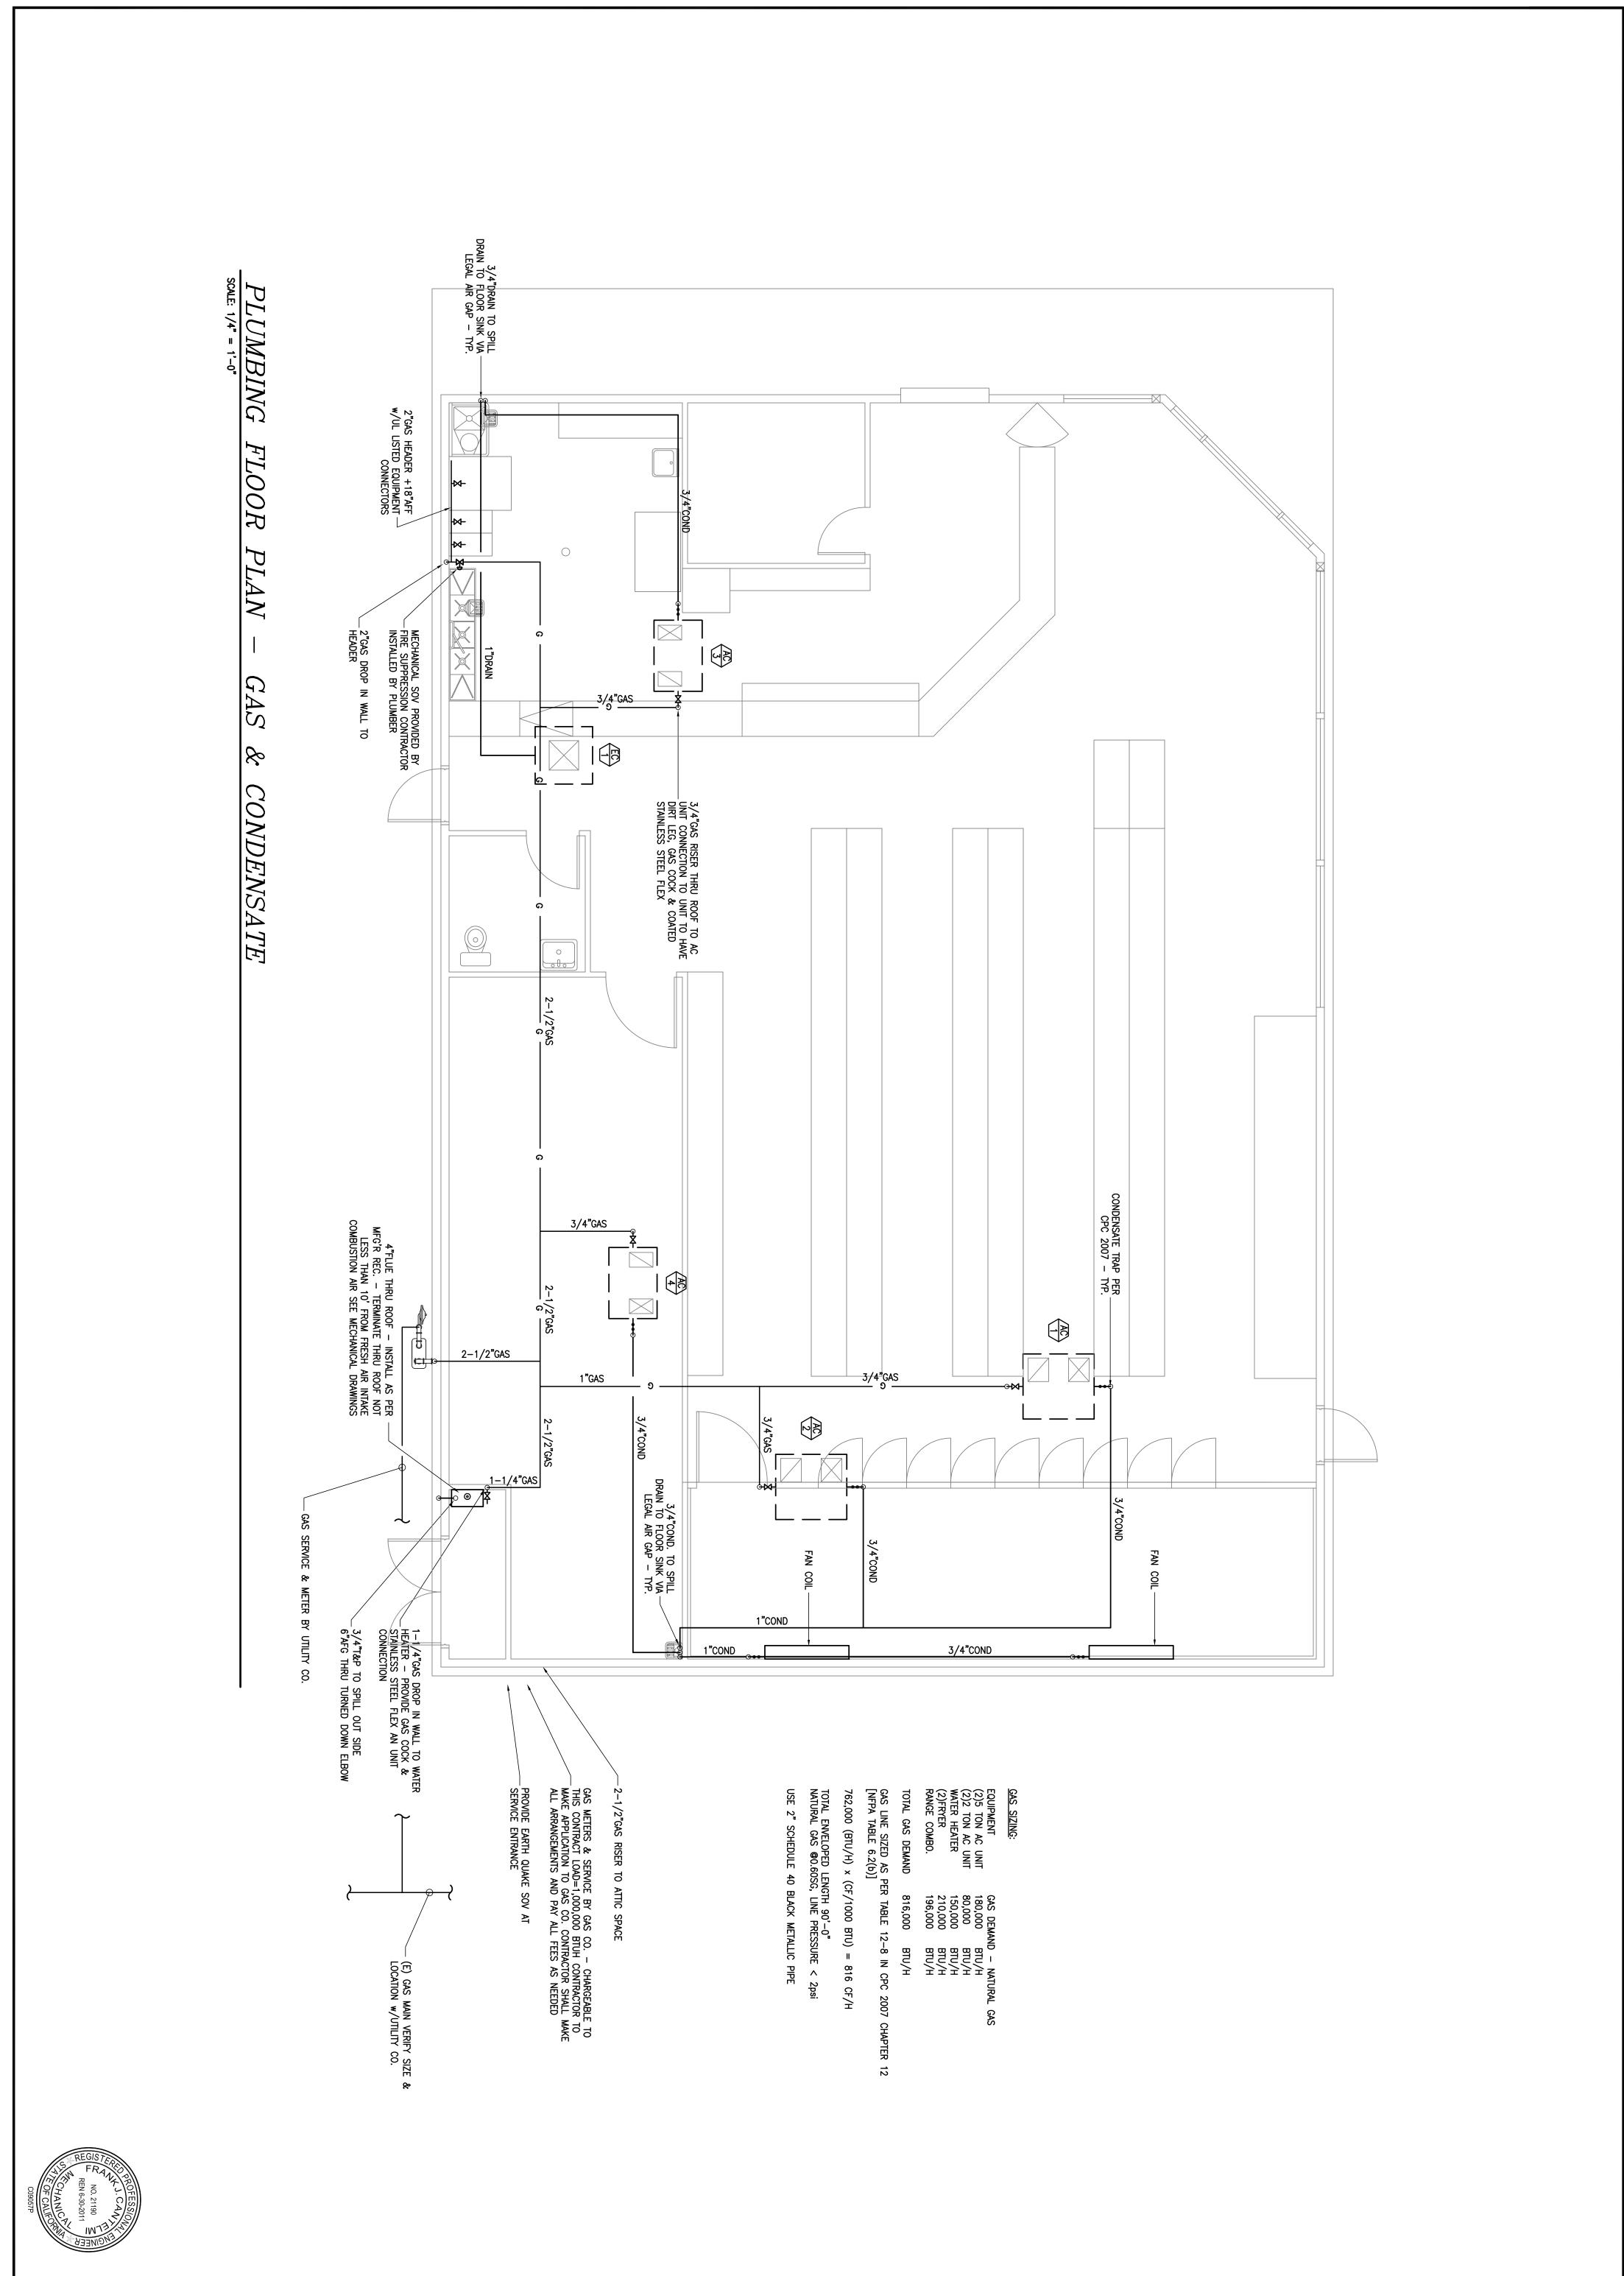




PLUMBING FLOOR PLAN - GAS & CUNDENSAIL
PROPOSED CONVENIENCE STORE FOR: PLUMBING FLOOR PLAN - GAS & CONDENSATE REVISION DATE 12/18/2009 DRAWN 12/18/09 WILLIES MARKET 690 N ELMWOOD AVE LINDSAY, CA 057

Glenn Hartzell-Architect

1800 21st STREET, SUITE C BAKERSFIELD, CALIFORNIA 93301 ARCHITECT C-10298



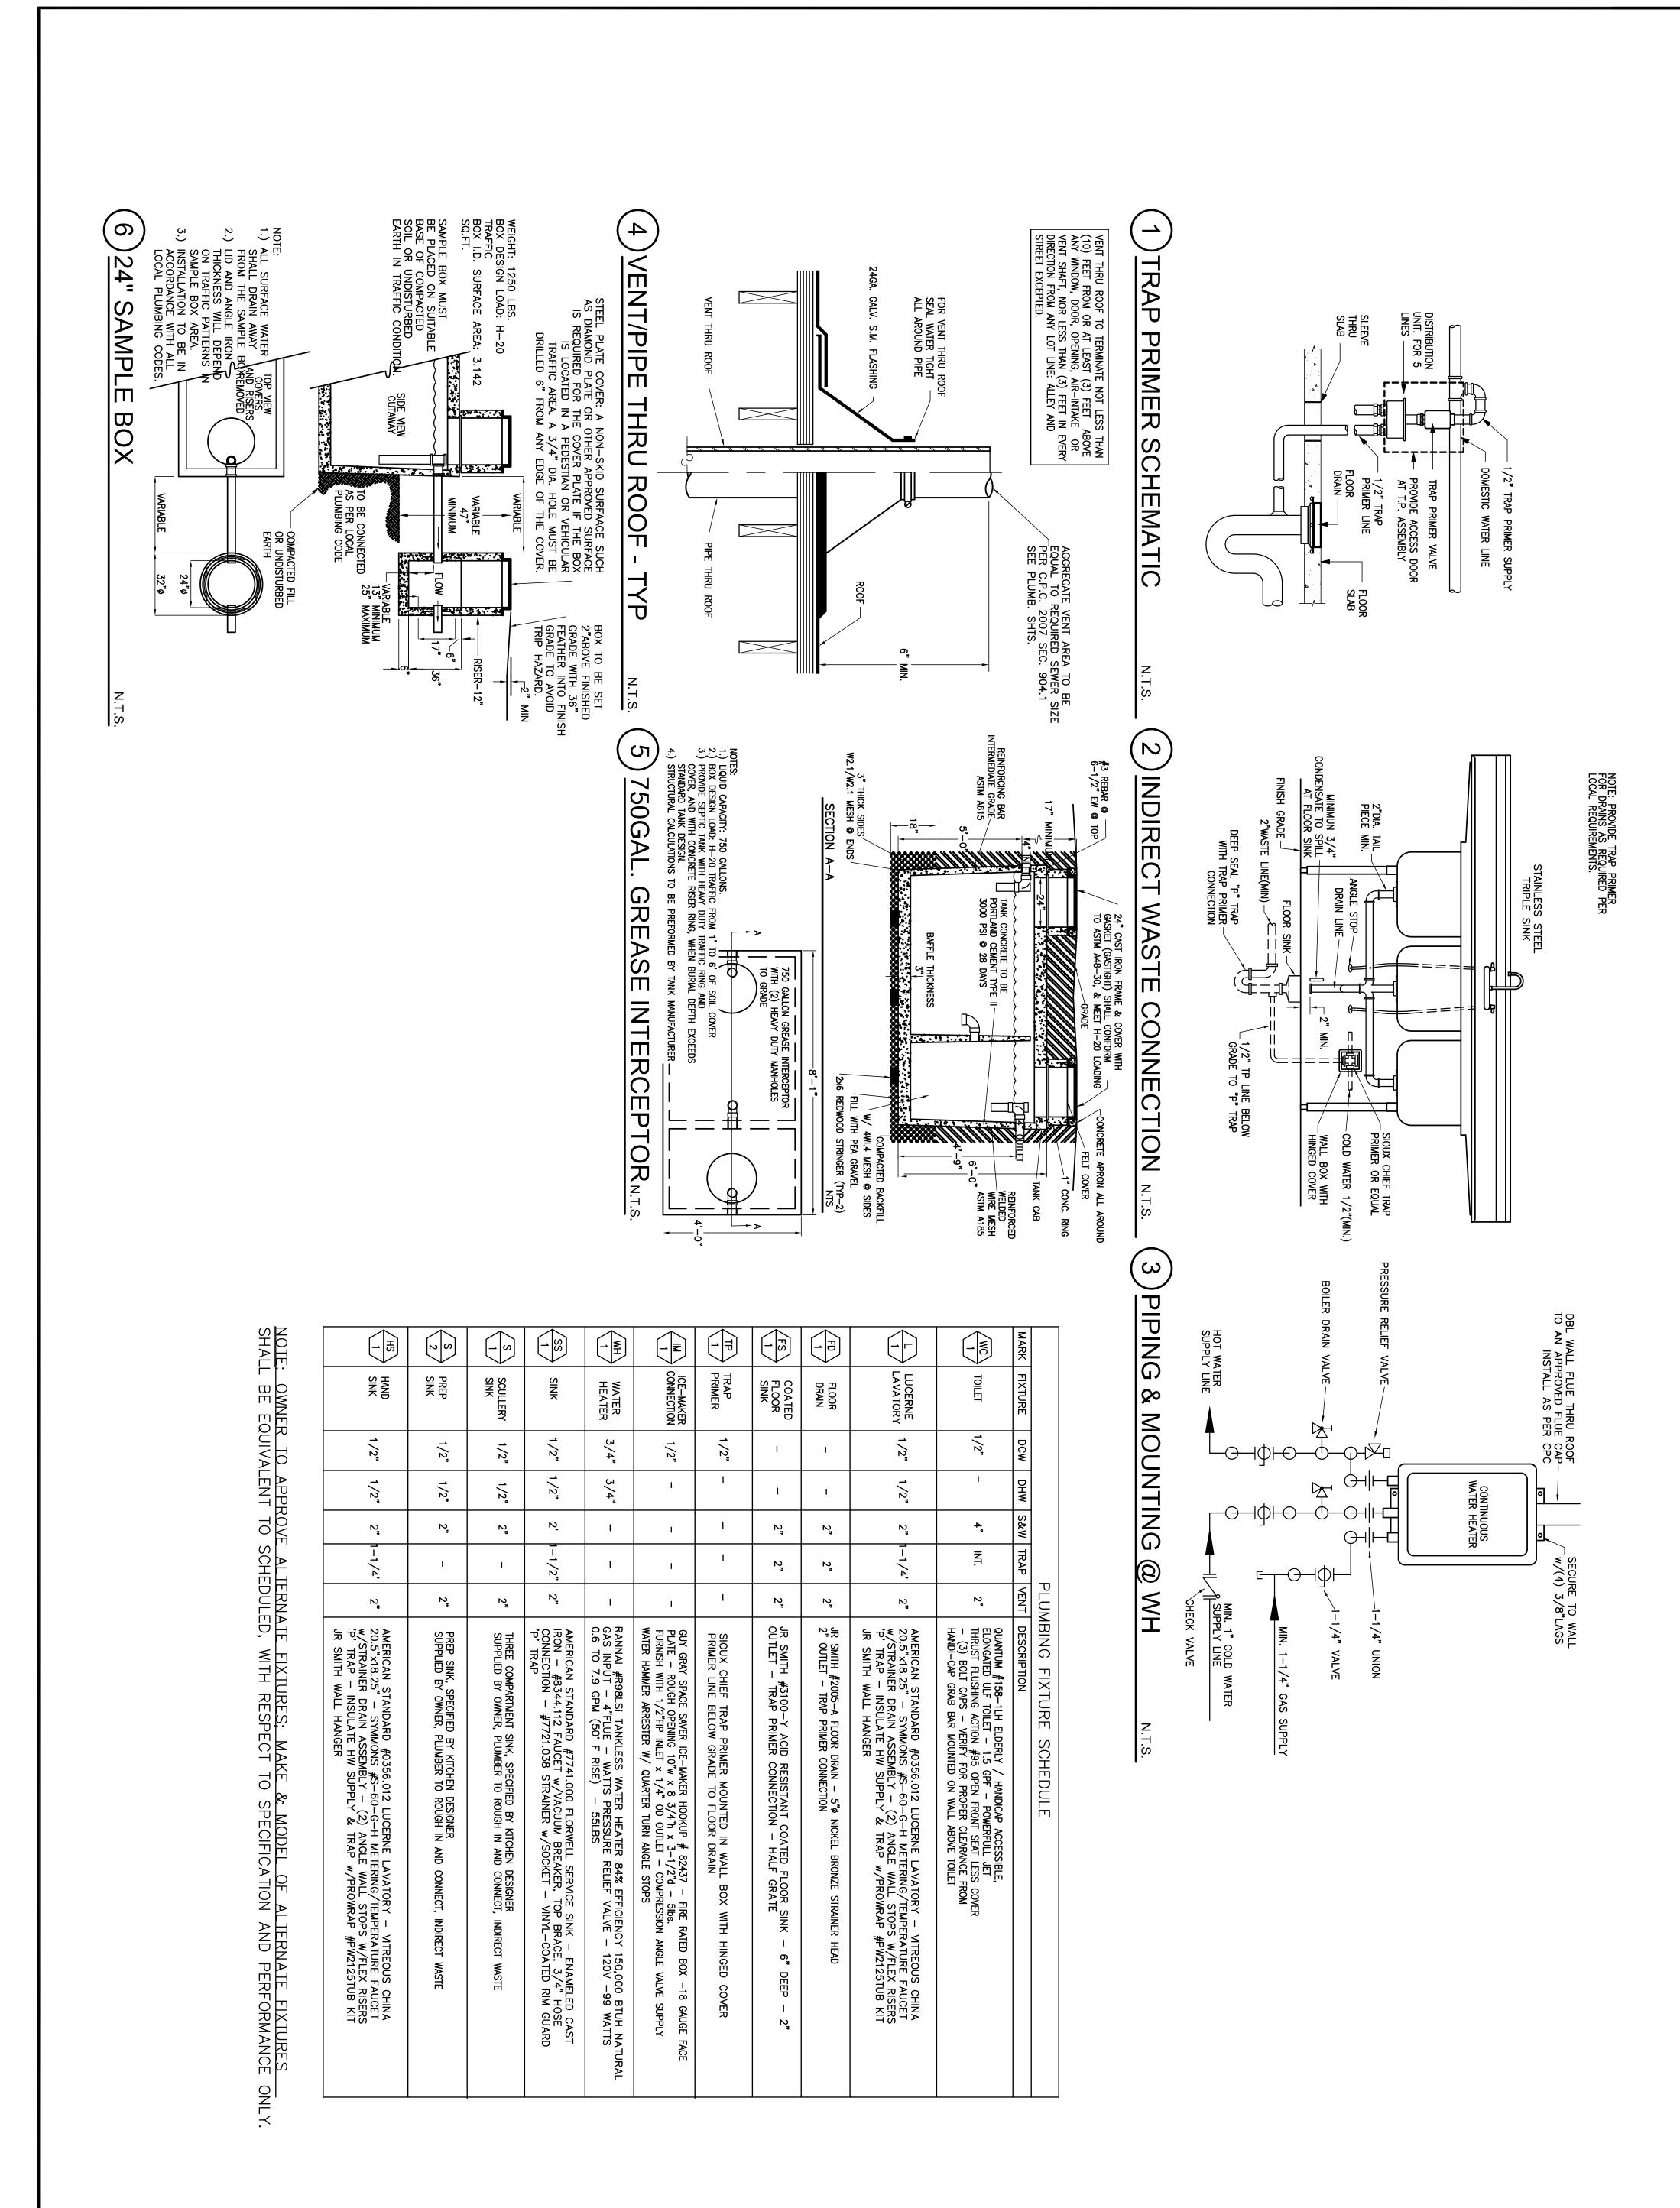




	0	PLUMBING DETAILS - FIXTURE SCHEDULE		REVISION
SHEE	6C	PROPOSED CONVENIENCE STORE FOR:	DATE	DATE
믜			12/18/2009	12/18/09
ᅴ	OS	WILLIES MARKET	DRAWN	, ,
8	5	690 N ELMWOOD AVE	A.F.	
	7	LINDSAY, CA	/.i ·	





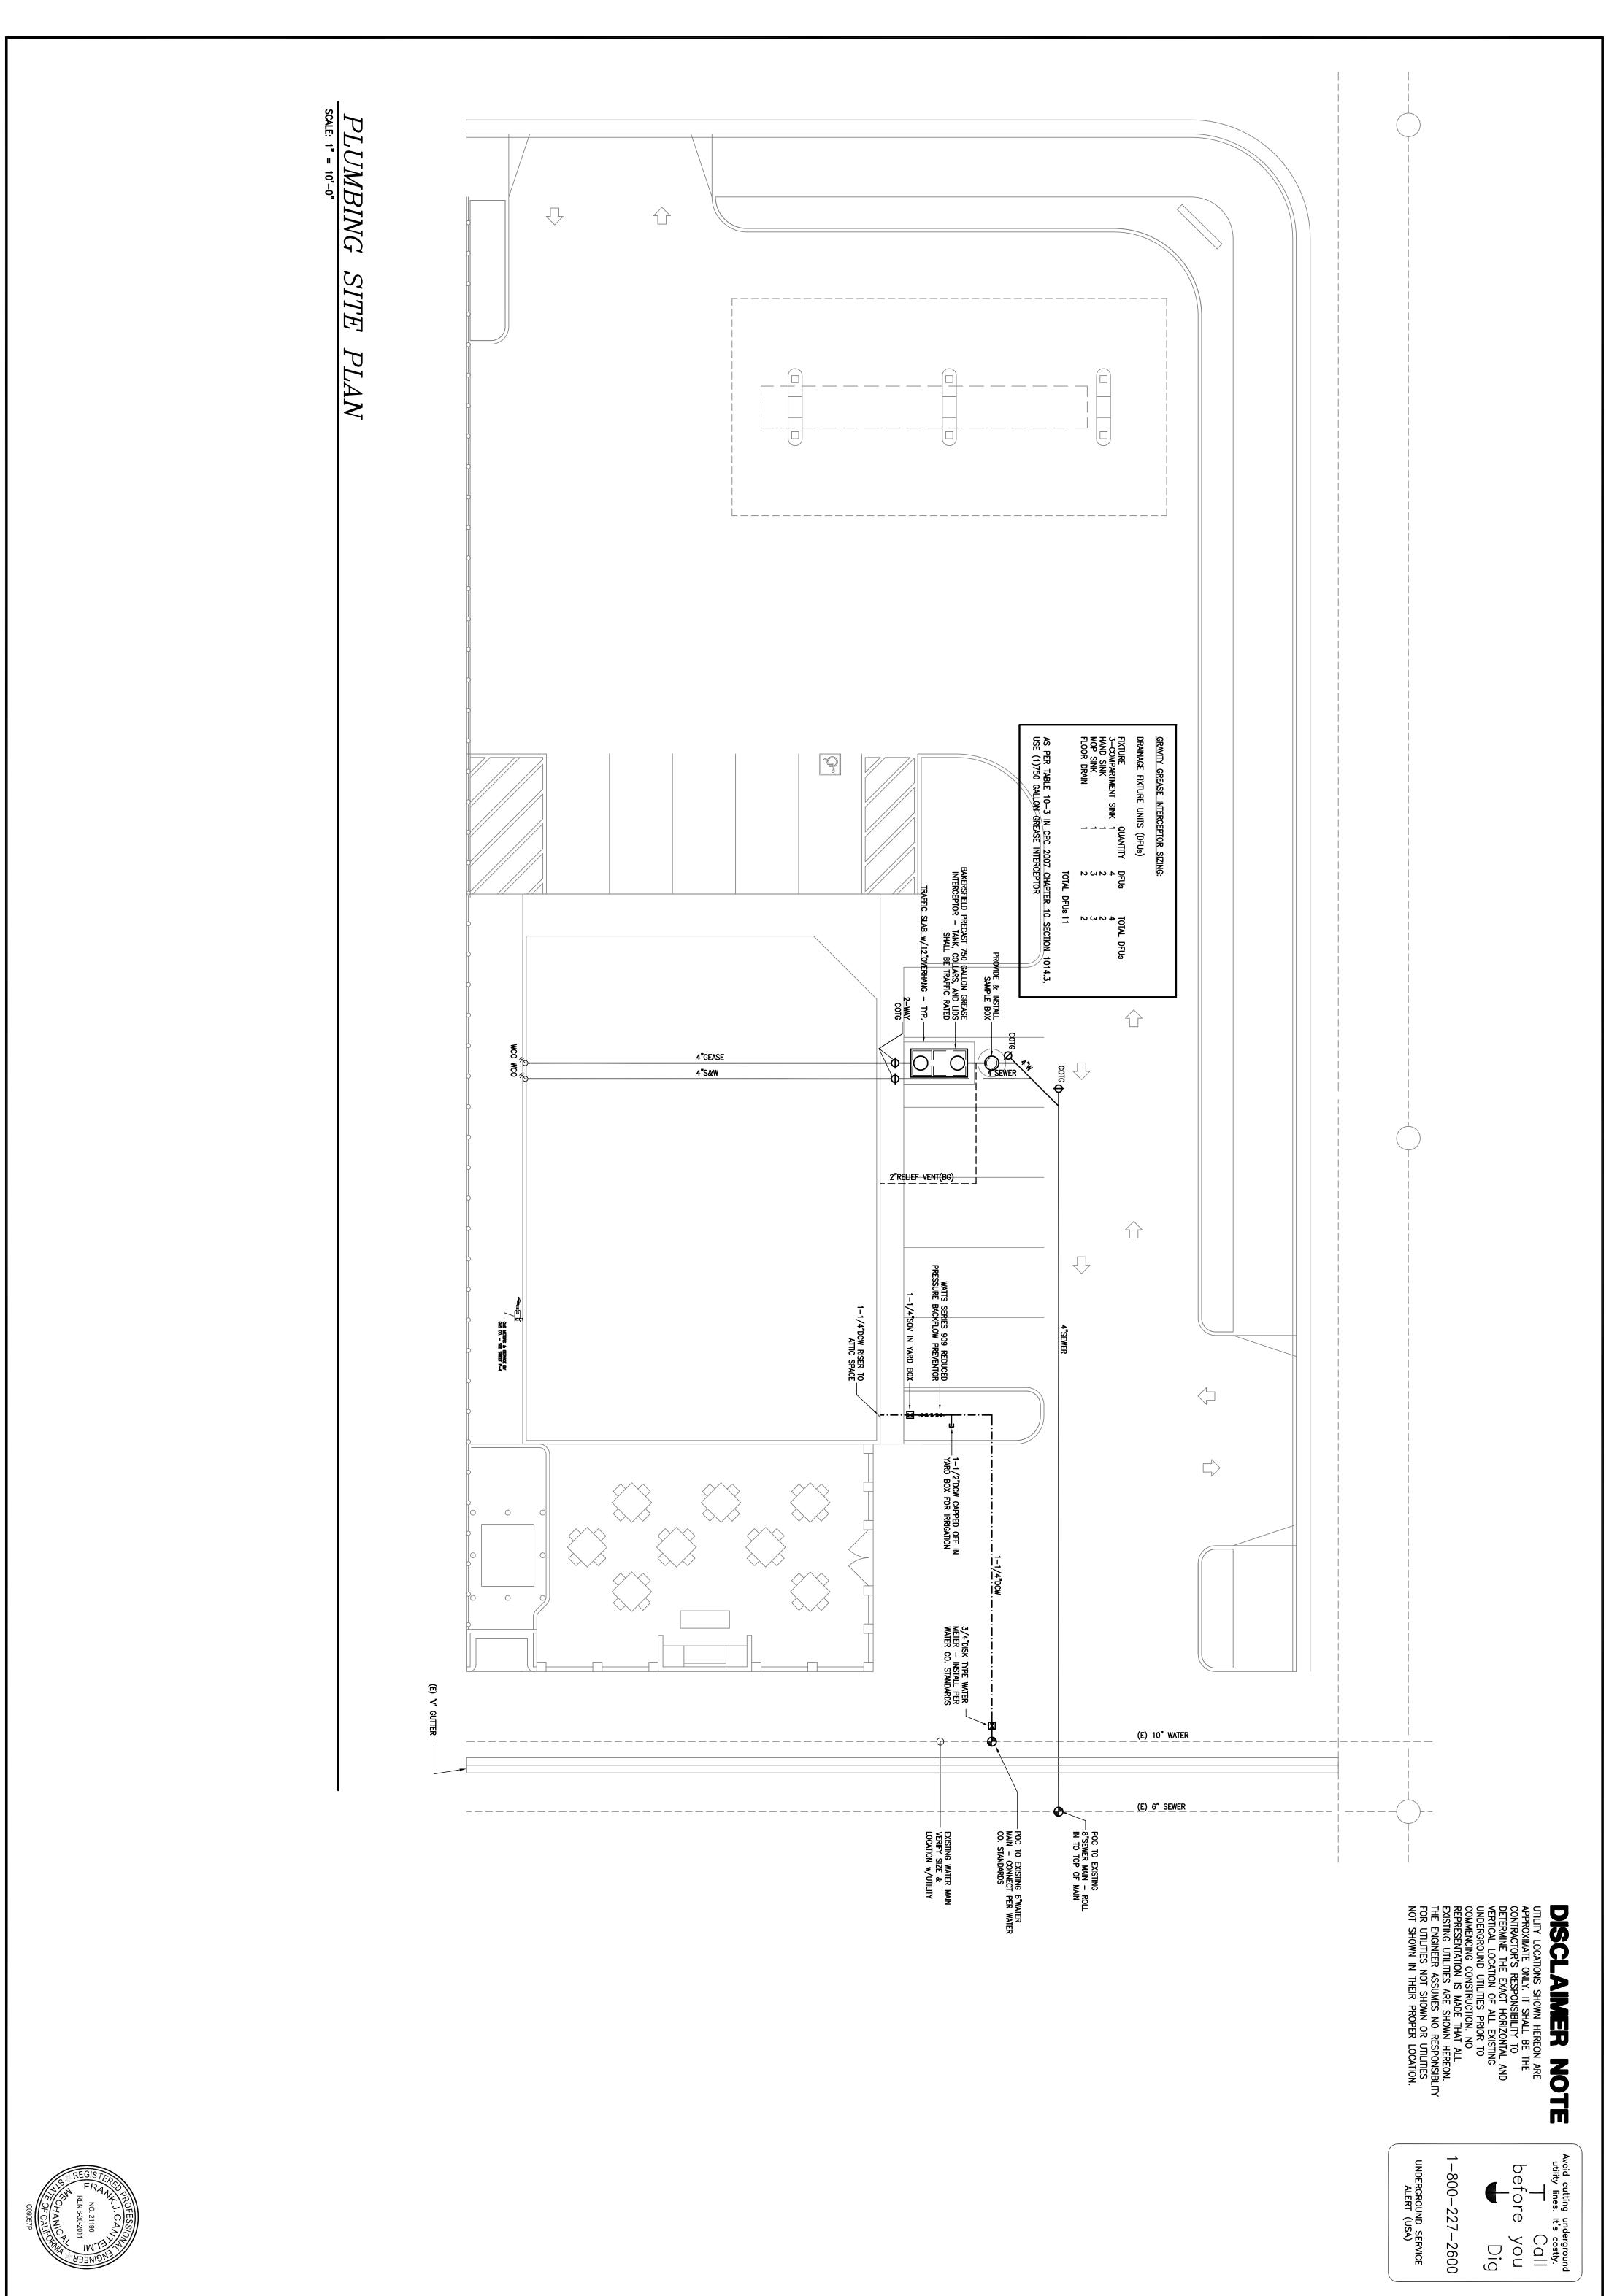

REVISION

DATE

12/18/09

PLUMBING SITE PLAN
PROPOSED CONVENIENCE STORE FOR:


057

WILLIES MARKET 690 N ELMWOOD AVE LINDSAY, CA

Glenn Hartzell-Architect 1800 21st STREET, SUITE C BAKERSFIELD, CALIFORNIA 93301

ARCHITECT C-10298



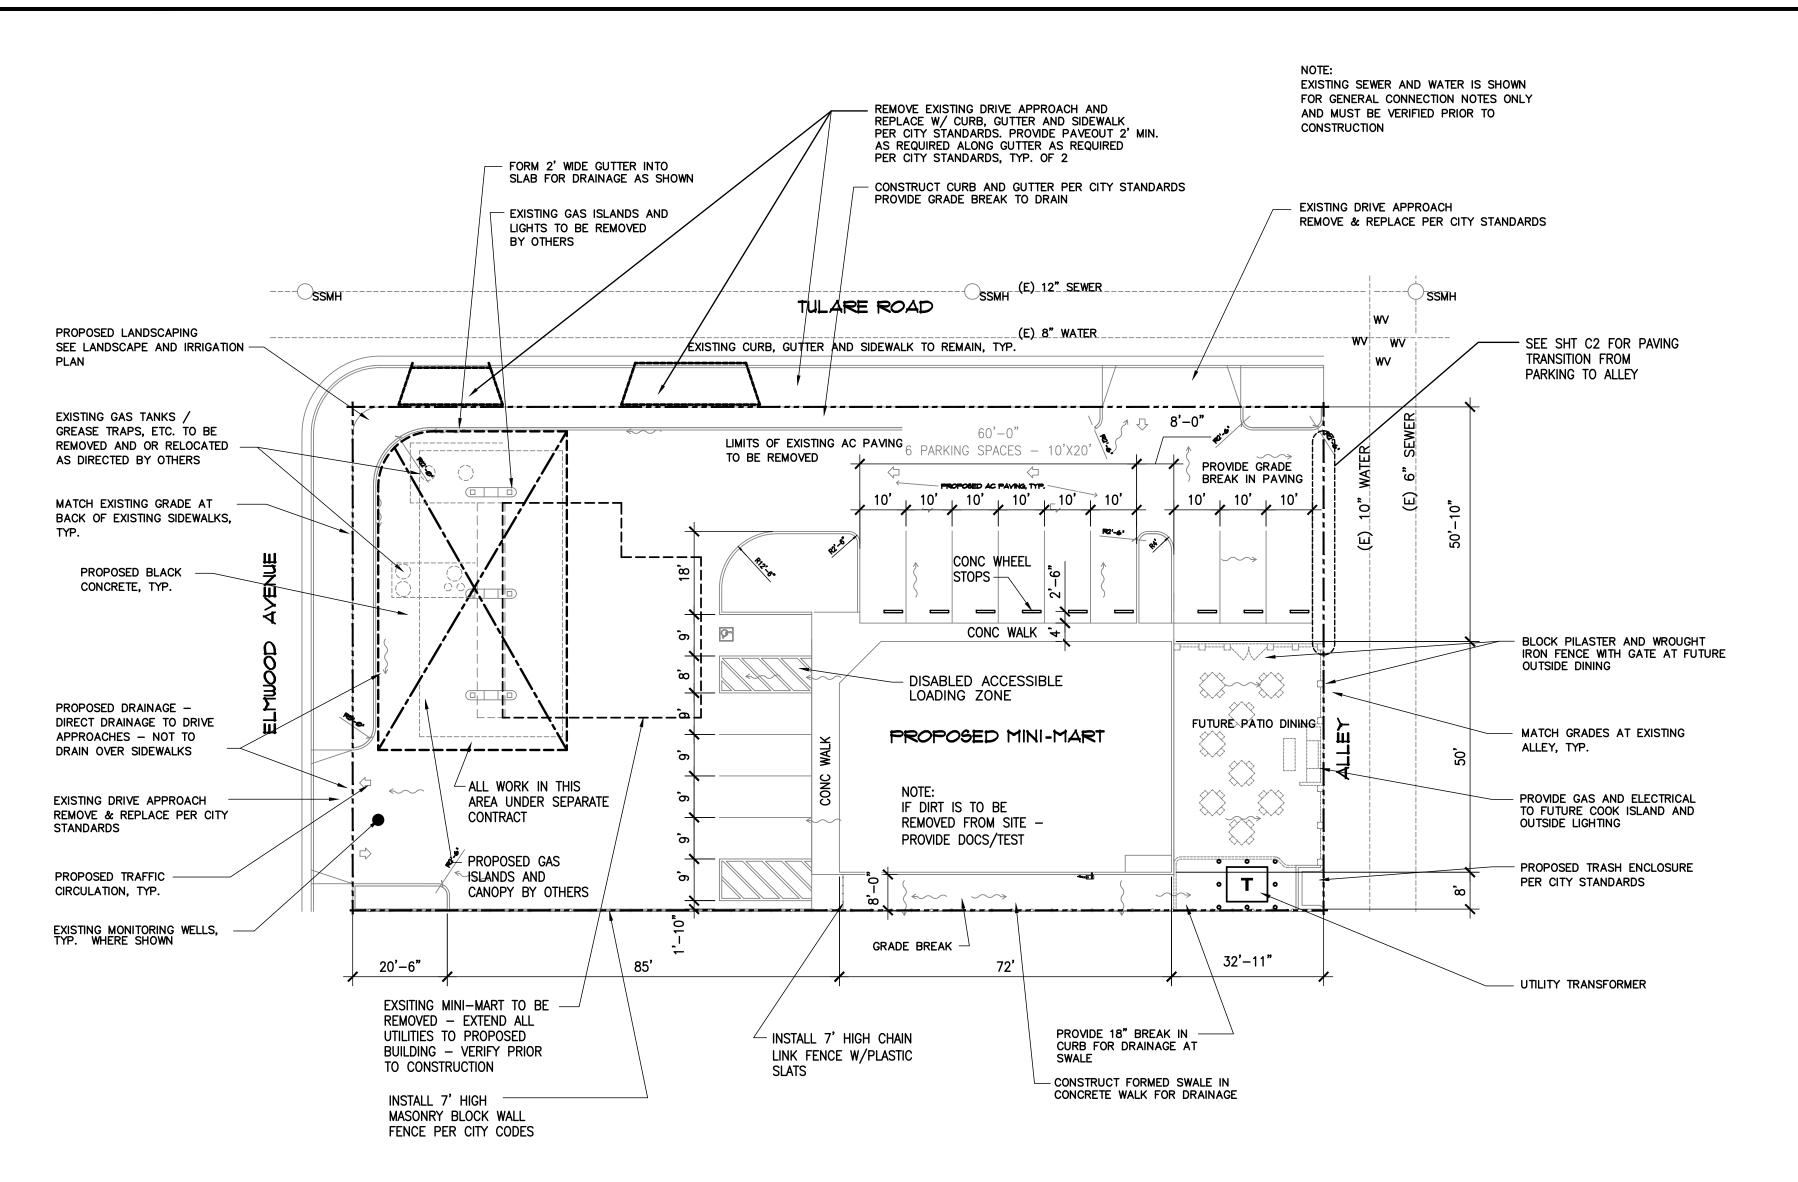


VICINITY MAP

### SITE PLAN



SCALE : 1" =20'

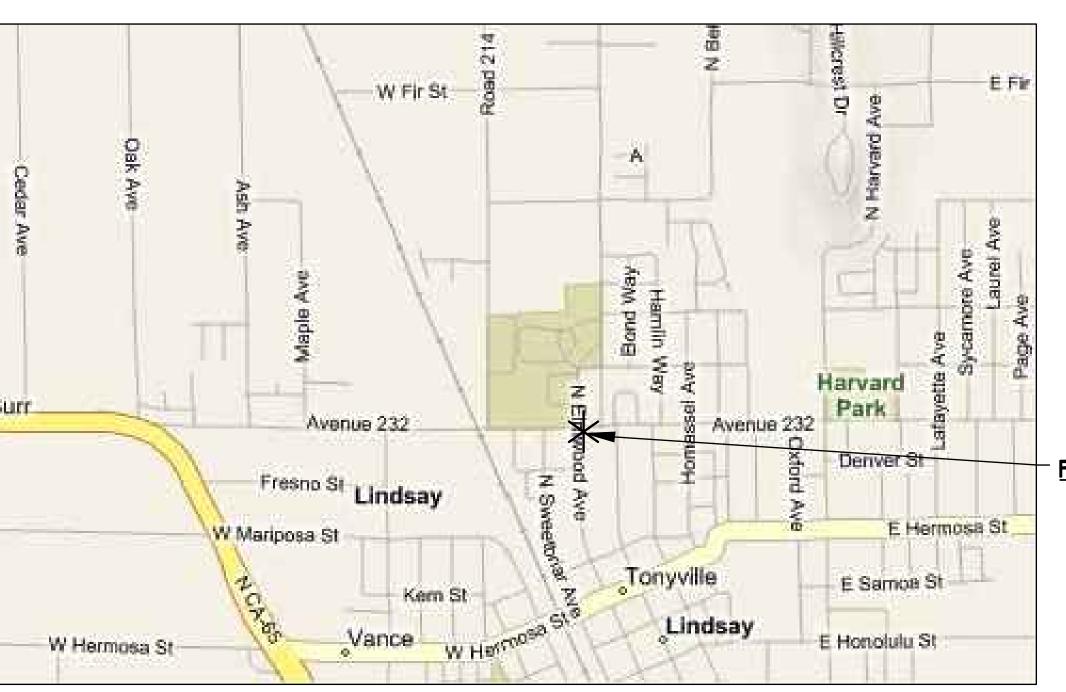

### SITE SUMMARY

LEGAL DISCRIPTION = 690 N ELMWOOD AVE = 205-093-003APN No. LOCAL ZONING = CN

= NEIGHBORHOOD COMMERCIAL EXISTING USE SQUARE FOOTAGE = 2,017 SF - THIS SPACE

### **BUILDING SUMMARY**

PROPOSED USE = MINI MARKET CONSTRUCTION TYPE = TYPE V, NON RATED NUMBER OF STORIES = ONE BUILDING HEIGHT = 28'-6"OCCUPANCY GROUP = -OCCUPANT LOAD = -

### **PARKING**

NEW WILLIES MARKET

540 SF STORAGE KIT/OFFICE/COUNTER - 200 = 3.4680 SF 363 SF 2,017 SF WALK-IN BOX SF STORE 13.4 REQUIRED 15.0 SPACES

### **BUILDING CODES**

THIS PROJECT SHALL COMPLY W/ THE CURRANT APPROVED CODES BY LOCAL AUTHORITY AND THIS PROJECT SHALL COMPLY W/ THE FOLLOWING CODES:

2007 CA. BUILDING CODE (CBC) 2007 CA. MECHANICAL CODE (CMC) 2007 CA. PLUMBING CODE (CPC) 2007 CA. ELECTRICAL CODE (CEC) 2005 CA. ENERGY EFFICIENCY STANDARD CODE (CECS) 2007 CA. HISTORICAL CODE 2007 CA. EXISTING BUILDING CODE

ACCESS FOR THE DISABLED - PER STATE & LINDSAY COUNTY ORDINANCES AND THEIR AMENDMENTS:

### **DIRECTORY**

PLUMBING/MECHANICAL FRANK CANTELMI ENGINEERING ENGINEER: 1800 21st ST. STE C

BAKERSFIELD, CA 93301 TEL: (661) 324-5252 FAX: (661) 324-8439 REP: FRANK CANTELMI EMAIL: CANTELMI@CANTELMI.NET


ARCHITECT/ELECTRICAL:

GLENN HARTZELL 1800 21st ST. STE C BAKERSFIELD, CA TEL: (661) 324-5252 FAX: (661) 324-8439

### SHEET INDEX

VICINITY MAP - SITE PLAN - GENERAL NOTES GD-1.0 GRADING NOTES GD-2.0 GRADING SITE PLAN A-2FLOOR PLAN REFLECTED CEILING PLAN - DETAILS A-3A-4 EXTERIOR ELEVATIONS — DETAILS EXTERIOR ELEVATIONS A-5 A-6 PARTIAL FLOOR PLAN - EQUIPMENT SCHEDULE FOUNDATION PLAN - DETAILS - SHEAR SCHEDULE ROOF FRAMING PLAN — SECTIONS A-9 ROOF PLAN - DETAILS DOOR SCHEDULE - WINDOW SCHEDULE - NOTES P-1 PLUMBING NOTES & SYMBOLS — ABBREVIATIONS PS-1 PLUMBING SITE PLAN P-2 PLUMBING FLOOR PLAN - WASTE & VENT P-3PLUMBING FLOOR PLAN - DCW & DHW PLUMBING FLOOR PLAN - GAS, CONDENSATE P-4 PLUMBING DETAILS - FIXTURE SCHEDULE P-5 M-1MECHANICAL NOTES & SYMBOLS - ABBREVIATIONS MECHANICAL PLAN - EQUIPMENT SCHEDULE - NOTES M-2MECHANICAL DETAILS M-3M-4EXHAUST HOOD DETAILS ELECTRICAL SITE PLAN - DETAILS ELECTRICAL NOTES & SYMBOLS - ABBREVIATIONS ELECTRICAL POWER PLAN E-2 ELECTRICAL LIGHTING PLAN E-3E-4 ELECTRICAL POWER ROOF PLAN E-5 ONE LINE - FIXTURE SCHEDULE - PANEL SCHEDULES LANDSCAPE & IRRIGATION NOTES TITLE 24 COMPLIANCE T-24

### PROJECT LOCATION

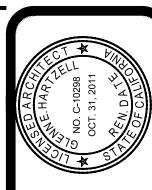

**6** 252

9330 ₹ }

0

STORI

MILLIES MARKET

WILLIES MARKET

690 N ELMWOOD AVE

JOB C09 - 057SHEET NO.

SHEET 1 OF 1

